### CITY OF DANA POINT PLANNING COMMISSION AGENDA REPORT

**DATE:** OCTOBER 14, 2019

TO: DANA POINT PLANNING COMMISSION

FROM: COMMUNITY DEVELOPMENT DEPARTMENT

MATT SCHNIEDER, COMMUNITY DEVELOPMENT DIRECTOR

JOHN CIAMPA, SENIOR PLANNER

SUBJECT: COASTAL DEVELOPMENT PERMIT CDP19-0012 TO ALLOW AN

ADDITION AND REMODEL TO A LEGAL NONCONFORMING HOUSE ON A COASTAL BLUFF LOT LOCATED IN THE RSF-3 ZONING

**DESIGNATION AT 34821 DOHENY PLACE** 

**RECOMMENDATION**: That the Planning Commission adopt the attached resolution

approving Coastal Development Permit CDP19-0012.

**APPLICANT:** Beth Billstein, Property Owner

REPRESENTATIVE: Rob Williams, Architect

REQUEST: Approval of a Coastal Development Permit to allow an

addition, remodel, new decks and a patio cover for a legal nonconforming house on a coastal bluff lot located within the City's Coastal Overlay District (the California Coastal Zone) and the Appeals Jurisdiction of the California Coastal

Commission.

**LOCATION**: 34821 Doheny Place (APN 123-233-10) (the "Property)

**NOTICE**: Notices of the Public Hearing were mailed to property owners

within a 500-foot radius and occupants within a 100-foot radius on October 4, 2019, published within a newspaper of general circulation on October 4, 2019, and posted on October 4, 2019 at Dana Point City Hall, the Dana Point and Capistrano Beach Branch Post Offices, as well as the Dana

Point Library.

**ENVIRONMENTAL**: Pursuant to the California Environmental Quality Act (CEQA),

the project is found to be Categorically Exempt per Section 15301 (Class 1 – Existing Facilities) in that the addition and remodel results in an expansion of less than 50 percent of the

structure's existing square footage.

### ISSUES:

- Project consistency with the Dana Point General Plan and Local Coastal Program Land Use Plan/Implementing Actions Program (LCP).
- Project satisfaction of all findings required pursuant to the LCP for approval of a Coastal Development Permit (CDP).
- Project compatibility with and enhancement of the site and surrounding neighborhood.

### **BACKGROUND**:

The Property is a legal lot totaling .37 acres (15,681 square feet) and fronts Doheny Place to the east and a coastal bluff (as defined in Section 9.27.030 of the DPMC) to the west. The Property contains a two-story, 3,455 square foot, single-family residence, and attached two-car garage that is bordered on three sides by residential development and a hotel on the bluff side. The Property is zoned Residential Single-Family 3 (RSF-3), located in the City's Coastal Overlay District, and the Appeals Jurisdiction of the California Coastal Commission.

The house is a legal nonconforming structure because it was constructed in 1954, prior to the current development standards and the Coastal Act with a 14-foot coastal bluff setback when a 25-foot setback is now required. The house is also legal nonconforming because it only provides five-foot side yard setbacks (north and south side yards) when eight feet is required, and the interior dimension of the garage is only 19.25 feet when 20 feet is required.

### DISCUSSION:

The applicant is requesting an addition and remodel to reconfigure the living accommodations for the SFD to meet modern-day needs. The proposal would remodel the four bedrooms and bathrooms and create a kitchen/great room area. The project also includes two new decks and a patio cover on the bluff side of the structure. The project would enlarge the 3,455 square foot, two-story, house with a 66 square foot basement level addition, 95 square foot first story addition, and a 44 square foot garage addition to expand the house to 3,612 square feet and attached garage to 491 square feet.

Per Section 9.63.030(a) a Minor Site Development Permit is not required for the proposed 205 square foot addition to the legal nonconforming structure because it complies with all of the required setbacks and is less than 10 percent (5.6 percent expansion proposed) of the existing structure's square footage. The addition is permissible subject to the approval of the Coastal Development Permit.

Table 1 summarizes the applicable RSF-3 development standards and the project's conformance with those requirements:

Table 1: Compliance with RSF-3 Development Standards

Development Standard	Requirement	Proposed/Existing	Compliant with Standard
Front Setback	10 feet minimum	29.6 feet	Yes
Side Setbacks (north) Side Setbacks (south)	8 feet minimum	5.7 feet* 5 feet*	No No
Rear Setback	25 feet minimum	14 feet*	No
(Bluff Setback)	from edge of bluff	from edge of bluff	
Height	28 feet maximum	28 feet	Yes
	(6/12 roof pitch)	(6/12 roof pitch)	
Lot Coverage	35% maximum	29%	Yes
Parking Required	2 parking spaces	2 parking spaces	Yes

<sup>\*</sup>Existing legal nonconforming condition that is not proposed to be expanded.

The neighborhood of the subject property consists of one and two-story houses with varied architectural styles. The project proposes to modify the house's nondescriptive architecture to a contemporary Asian design, as described by the architect, with new exterior finishes and roof design that would increase the height to 28 feet. The proposed façade improvements included el dorado stone veneer accents, new windows and doors, concrete roof tile, new stucco finish, and copper gutters.

### Coastal Development Permit CDP19-0012

Pursuant to Section 9.69.040 of the Dana Point Zoning Code, the proposed increase in volume of the structure with the new roof design and the new decks and patio cover within 50 feet of the coastal bluff edge in the City's Coastal Overlay District and the Appeals Jurisdiction of the California Coastal Commission requires the approval of a CDP. The project complies with all of the applicable provisions of the Dana Point Zoning Code for the issuance of a CDP as the addition and remodel does not impact the coastal bluff, public access, or impact any Environmentally Sensitive Habitat Areas (ESHA).

#### Coastal Bluff

The subject property's location on a coastal bluff lot requires the submittal of a geotechnical report to determine the location of the edge of the coastal bluff (the point at which the site alters from generally flat to begin its topographic descent to the Pacific Ocean below), historic and projected future erosion of the site, as well as general site stability. The geotechnical analysis supports a coastal bluff setback of 25 feet. The

proposed improvements are set back 25 feet from the delineated edge of the coastal bluff and no foundations are in the required bluff setback. The conclusions contained in the project's geotechnical report and the project's overall design were reviewed and corroborated by the City's Geotechnical and Structural Engineers. The project does not propose any development within the coastal bluff.

Section 9.69.070 of the DPZC stipulates a minimum of seven (7) findings to approve a Coastal Development Permit, requiring that the project:

- 1. Be in conformity with the certified Local Coastal Program as defined in Chapter 9.75 of this Zoning Code. (Coastal Act/30333, 30604(b); 14 CA Code of Regulations/13096).
- If located between the nearest public roadway and the sea or shoreline of any body of water, be in conformity with the public access and public recreation policies of Chapter Three of the Coastal Act. (Coastal Act/30333, 30604(c); 14 CA Code of Regulations/13096).
- 3. Conform with Public Resources Code Section 21000 and following, and there are no feasible mitigation measures or feasible alternatives available which would substantially lessen any significant adverse impact that the activity may have on the environment. (Coastal Act/30333; 14 CA Code of Regulations/13096).
- 4. Be sited and designed to prevent adverse impacts to environmentally sensitive habitats and scenic resources located in adjacent parks and recreation areas, and will provide adequate buffer areas to protect such resources.
- 5. Minimize the alterations of natural landforms and not result in undue risks from geologic and erosional forces and/or flood and fire hazards.
- 6. Be visually compatible with the character of surrounding areas, and, where feasible, will restore and enhance visual quality in visually degraded areas.
- 7. Conform to the General Plan, Zoning Code, applicable Specific Plan, Local Coastal Program, or any other applicable adopted plans and programs.

The recommended findings for approval of the CDP are outlined in the draft Resolution No. 19-10-14-XX, attached to this report as Action Document 1.

**CORRESPONDENCE**: To date, no correspondence has been received regarding this project.

<u>CONCLUSION</u>: Staff finds that the proposed project is consistent with the policies and provisions of the City of Dana Point General Plan Zoning Ordinance and Local Coastal Program. As the project is found to comply with all standards of development, staff

recommends the Planning Commission adopt the attached draft Resolution, approving Coastal Development Permit 19-0012 subject to the findings and conditions of approval contained therein.

John Ciampa, Senior Planner

Watt Schneider, Director Community Development Department

### **ATTACHMENTS:**

### **Action Documents**

1. Draft Planning Commission Resolution No. 19-10-14-xx

### **Supporting Documents**

- 2. Vicinity Map
- 3. Site Photos
- 4. Color Rendering
- 5. Plans

Action Document 1: Draft Planning Commission Resolution

No. 19-10-14-xx

**ACTION DOCUMENT 1** 

#### **RESOLUTION NO. 19-10-14-XX**

A RESOLUTION OF THE PLANNING COMMISSION OF THE CITY OF DANA POINT, CALIFORNIA, APPROVING COASTAL DEVELOPMENT PERMIT 19-0012 TO ALLOW THE ADDITION AND REMODEL OF A LEGAL NONCONFORMING HOUSE ON A COASTAL BLUFF LOT LOCATED IN THE RESIDENTIAL SINGLE-FAMILY 3 (RSF-3) ZONING DISTRICT AT 34821 DOHENY PLACE

The Planning Commission for the City of Dana Point does hereby resolve as follows:

WHEREAS, Beth Billstein (the "Applicant") is the owner of the real property commonly referred to as 34821 Doheny Place (APN 123-233-10) (the "Property"); and

WHEREAS, the Applicant filed a verified application for a Coastal Development Permit to allow the addition and remodel to a legal nonconforming house on a coastal bluff lot; and

WHEREAS, said verified application constitutes a request as provided by Title 9 of the Dana Point Municipal Code; and

WHEREAS, pursuant to the California Environmental Quality Act (CEQA), the project is Categorically Exempt per Section 15301 (Class 1 – Existing Facilities) in that the application proposes an addition of less than 50 percent of the existing structure's square footage and a remodel; and

WHEREAS, the Planning Commission did, on the 14<sup>th</sup> day of October, 2019, hold a duly noticed public hearing as prescribed by law to consider said request; and

WHEREAS, at said public hearing, upon hearing and considering all testimony and arguments, if any, of all persons desiring to be heard, said Commission considered all factors relating to Coastal Development Permit CDP19-0012.

NOW, THEREFORE, BE IT HEREBY RESOLVED by the Planning Commission of the City of Dana Point as follows:

- A. That the above recitations are true and correct and incorporated herein by this reference.
- B. Based on the evidence presented at the public hearing, the Planning Commission adopts the following findings and approves CDP19-0012 subject to the following conditions of approval:

#### Findings:

Coastal Development Permit CDP19-0012

- That the project is in conformity with the certified Local Coastal Program as defined in Chapter 9.75 of this Zoning Code. (Coastal Act/30333, 30604(b); 14 Cal. Code of Regulations/13096) in that, the project is consistent with all goals and policies of the Residential 0-3.5 land use designation. The house remains a two-story, single-family residence. The proposed addition and remodel complies with the applicable development standards and the 25-foot bluff setback, and none of the legal nonconformities to the structure are intensified as part of the project. While the house is located in the 25-foot coastal bluff setback, no new footings are proposed in the required setback for the addition or remodel.
- 2. That the proposed development is not located between the nearest public roadway and the sea or shoreline of any body of water, and is in conformity with the public access and public recreation policies of Chapter Three of the Coastal Act in that, the proposed development does not alter existing public access or recreation areas in the vicinity as there are none on or adjacent to the property.
- 3. That the project conforms to Public Resources Code Section 21000 (the California Environmental Quality Act CEQA) and following, that there are no feasible mitigation measures or feasible alternatives available which would substantially lessen any potentially significant adverse impact that the activity may have on the environment (Coastal Act/30333; 14 Cal. Code of Regulations/13096) in that the project qualifies as Categorically Exempt from review under CEQA pursuant to Section 15301 (Class 1 Existing Facility) therefore, no mitigation is required. The project is a Class 1 exemption because it proposes an addition and remodel that results in an expansion of less than 50 percent of the structure's existing square footage.
- 4. That the project has been sited and designed to prevent adverse impacts to environmentally sensitive habitats and scenic resources located in adjacent parks and recreation areas, and will provide adequate buffer areas to protect such resources in that, the proposed development is not adjacent to environmentally sensitive habitat areas or scenic resources as the site is a developed lot. The structure does not encroach any further towards the coastal bluff setback and the additions will not be located near sensitive habitat or scenic resources. The project is not proposing any new landscaping or site modifications in the bluff setback which will avoid any impacts to environmentally sensitive habitats or scenic resources.
- That the project minimizes the alteration of natural landforms and will not result in undue risks from geologic and erosional forces and/or flood and

fire hazards in that the proposed additions are located outside of the 25-foot coastal bluff setback and no structural foundations are proposed in this setback area. The City reviewed the geotechnical report and project design and concluded the proposed improvements do not result in any natural landform alterations or undue risk for geologic or erosional forces.

- 6. That the project is visually compatible with the character of surrounding areas, and, where feasible, will restore and enhance visual quality in visually degraded areas in that the additions are architecturally integrated into the structure design to be compatible with the neighborhood. The proposed addition and remodel conform to the development standards of the RSF-3 zoning district and the Coastal Overlay District.
- 7. That the project conforms with the General Plan, Zoning Code, applicable Specific Plan, Local Coastal Program, or any other applicable adopted plans and programs in that the project was reviewed by Planning and Building/Safety Division and the Public Works/Engineering Department and found to conform with the applicable development standards per the Dana Point Zoning Code (which serves as the implementing document for the General Plan and Local Coastal Program for the subject property) including the 25 foot bluff setback requirement. The project complies with the City's Urban Design Element of the General Plan in that it maintains the structure's sense of address, mass, and design of the house. The project preserves the house as a single-family dwelling. There are no adopted specific plans that apply to the subject property.

### Conditions:

### General:

- 1. Approval of this application permits a remodel and a 161 square foot addition to the house and a 44 square foot addition to the garage which results in a 3,616 square foot house and a 491 square foot garage located at 34821 Doheny Place in accordance with the plans on file with the Community Development Department. Subsequent submittals for this project shall be in substantial compliance with the plans presented to the Planning Commission, and in compliance with the applicable provisions of the Dana Point General Plan, Local Coastal Program and Zoning Code.
- 2. Approval of this application is valid for a period of 24 months (two years) from the noted date of determination. If the development approved by this action is not established, or a building permit for the project is not issued

within such period of time, the approval shall expire and shall thereafter be null and void.

- 3. The application is approved as a plan for the location and design of the uses, structures, features, and materials shown on the approved plans. Any demolition beyond that described in the approved plans or any relocation, alteration, or addition to any use, structure, feature, or material, not specifically approved by this application, will nullify this approving action. If any changes are proposed regarding the location of, or alteration to the appearance or use of any structure, an amendment to this permit shall be submitted for approval by the Director of Community Development. If the Director determines that the proposed change complies with the provisions, spirit and intent of this approval action, and that the action would have been the same for the amendment as for the approved site plan, he/she may approve the amendment without requiring a new public hearing.
- Failure to abide by and faithfully comply with any and all conditions attached to the granting of this permit shall constitute grounds for revocation of said permit.
- This Resolution shall be copied in its entirety, placed directly onto a separate plan sheet behind the cover sheet of any plans submitted to the City of Dana Point Building/Safety Division for plan check.
- 6. The Applicant or any successor-in-interest shall defend, indemnify, and hold harmless the City of Dana Point ("CITY"), its agents, officers, or employees from any claim, action, or proceeding against the CITY, its agents, officers, or employees to attack, set aside, void, or annul an approval or any other action of the CITY, its advisory agencies, appeal boards, or legislative body concerning the project. Applicant's duty to defend, indemnify, and hold harmless the City shall include paying the CITY's attorney fees, costs and expenses incurred concerning the claim, action, or proceeding.
- 7. The Applicant or any successor-in-interest shall further protect, defend, indemnify and hold harmless the City, its officers, employees, and agents from any and all claims, actions, or proceedings against the City, its offers, employees, or agents arising out of or resulting from the negligence of the Applicant or the Applicant's agents, employees, or contractors. Applicant's duty to defend, indemnify, and hold harmless the City shall include paying the CITY's attorney fees, costs and expenses incurred concerning the claim, action, or proceeding. The Applicant shall also reimburse the City for City Attorney fees and costs associated with the review of the proposed project and any other related documentation.
- 8. The Applicant and owner, and their successors in interest, shall be fully responsible for knowing and complying with all conditions of approval,

including making known the conditions to City staff for future governmental permits or actions on the project site.

- 9. The project shall meet all water quality requirements including Low Impact Development (LID) implementation.
- 10. The applicant shall be responsible for coordination with water district, sewer district, SDG&E, AT&T California and Cox Communication Services for the provision of water, sewer, electric, cable television and telephone and services. The applicant is responsible to coordinate any potential conflicts or existing easements.
- 11. The applicant shall exercise special care during the construction phase of this project to prevent any off-site siltation. The applicant shall provide erosion and sediment control measures at all times. The applicant shall maintain the erosion and sediment control devices until the final approval of all permits.
- 12. The applicant, property owner or successor in interest shall submit a standard Waste Reduction and Recycling Plan to the City's C&D official per the Dana Point Municipal Code. A deposit will be required upon approval of the Waste Management Plan to ensure compliance. The standard Waste Reduction and Recycling Plan shall be reviewed and approved and deposit posted prior to issuance of any permits.
- 13. Prior to the commencement of any work within the public right-of-way, the applicant shall apply and be approved for an encroachment permit from the Public Works Department.
- 14. The applicant shall limit all construction activities within the coastal bluff-top setback area. The coastal bluff shall be protected at all times from potential erosion and construction activity.
- 15. The 25' bluff edge setback, per the zoning code and as shown on the submitted architectural plans and sections, shall be clearly shown and labeled on all plans submitted for review and approval.
- 16. Per Municipal Code Section 9.27.030, no new structure foundations or improvements requiring a building permit will be allowed within the codified 25' bluff edge setback. Review of the submitted architectural plans indicates that any potential foundation elements associated with the proposed building addition/remodel would be located behind (landward) of the indicated 25' bluff edge setback line. Should the existing foundations be found not suitable for the proposed structure/improvements during construction, new permitted foundations would be required to be landward of the 25' bluff edge setback. All design professionals should evaluate the existing foundation system of the

existing structure as it relates to the proposed work in order to verify that new foundation elements within the bluff edge setback will not be required as part of the proposed construction.

#### Prior to issuance of a Building Permit:

- 17. Minimum roofing classification is Class "A".
- 18. Undergrounding of all onsite utilities is required. An Approved SDG&E Work Order and Undergrounding Plan is required prior to permit issuance.
- 19. Building Code Analysis: Provide building code analysis showing conformance to the Chapter 3 and 5 of the CBC. Specify occupancy group(s), type(s) of construction, including fire sprinklers, location on property, actual and allowable floor area, building height, number of stories, and conforming exiting.
- 20. Fire sprinkler system is required.
- Soils Report (1803): Unless waived, submit a foundation and soils investigation report by a Registered Design Professional and conducted in conformance with CBC Section 1803.3 through 1803.5. The report shall comply with CBC Section 1803.6.
- 22. Foundation system to provide for expansive soils and soils containing sulfates unless a soils report can justify otherwise. Use Type V cement, w/c ratio of 0.45, fc of 4500 psi.
- Green Building: Plans shall show compliance & indicate method of verification of compliance with all CALGreen requirements. Third party or other methods shall demonstrate satisfactory conformance with mandatory measures.
- 24. The applicant shall submit a geotechnical report for the proposed construction in compliance with all City of Dana Point standards.
- 25. The applicant shall submit a drainage plan addressing the proposed construction in compliance with City standards, for review and approval by the Director of Public Works. The applicant shall include all plans and documents in their submittal in conformance with Public Works Department's plan check policies, City of Dana Point Municipal Code and the City of Dana Point Grading Manual and City's Municipal Separate Storm Sewer Systems (MS4s) Permit requirements. The drainage plan shall clearly show all drainage from proposed improvements being directed away from the bluff edge and to an approved outlet.

- 26. All plans submitted shall reflect the Bluff Edge and all associated setbacks as shown on the plans submitted September 6, 2019, and discussed in the "Response to City of Dana Point Public Works Review dated July 26, 2019, 34821 Doheny Place, Dana Point, California," and "Response to City of Dana Point Planning Division Correspondence dated July 26, 2019, 34821 Doheny Place, Dana Point, California," reports by Geofirm dated August 14, 2019 and September 26, 2019 respectively.
- 27. The applicant shall execute the City's standard deed restriction or, if prepared by the owner(s), shall be submitted for review and approval by the City Attorney. The deed restriction shall provide that; (1) the applicant understands that the subject site is subject to bluff retreat and that the owner(s) assumes the liability from these hazards; (2) the owner(s) unconditionally waive any claim of liability on the part of the City or any other public agency from any damage from such hazards; and (3) the owner(s) assume all liability for damages incurred as a result of any required off-site grading. The deed restriction shall be recorded, free of prior liens, to bind the owner(s) and any successors in interest or otherwise recorded to the satisfaction of the City Attorney.

#### Prior to final approval of all permits:

- 28. Prior to commencement of framing, a demolition inspection shall be conducted by the Building and Planning Departments to ensure conformance with the approved demolition plan.
- 29. Prior to the commencement of framing, the applicant shall submit a foundation certification, by survey, that the structure will be constructed in compliance with the dimensions shown on plans approved by the Planning Commission, including finish floor elevations and setbacks to property lines included as part of CDP19-0012. The City's standard "Line & Grade Certification" form shall be obtained from the Project Planner at time of building permit issuance, completed by a licensed civil engineer/surveyor and be delivered to the Building/Safety and Planning Divisions for review and approval.
- 30. Prior to the release of the roof sheathing inspection, the Applicant shall certify by a survey or other appropriate method that the height of the structure is in compliance with plans approved by the Planning Commission and the structure heights included as part of CDP19-0012. The City's standard "Height Certification" form shall be obtained from the Project Planner at time of permit issuance, prepared by a licensed civil engineer/surveyor and be delivered to the City of Dana Point Building and Planning Divisions for review and approval before release of final roof sheathing is granted.

- 31. All structural best management practices (BMPs) shall be constructed and installed in conformance with approved plans and specifications.
- 32. The final condition of the bluff edge setback shall be in accordance with Municipal Code Section 9.27.030, with no new structure foundations or improvements requiring a building permit within the 25-foot bluff edge setback.
- 33. Public Works final inspection and approval will be required for all permits.
- 34. The owner shall coordinate with the Planning Division to schedule a final site inspection to ensure the project was constructed per plan and all conditions of approval have been satisfied.

PASSED, APPROVED, AND ADOPTED at a regular meeting of the Planning Commission of the City of Dana Point, California, held on this 14th day of October, 2019 by the following vote, to wit:

	AYES:		
	NOES:		
	ABSENT:		
	ABSTAIN:		
			Roy Dohner Planning Commission
ATTEST:			
Matt Schneid	der, Director Development Depart		

**Supporting Document 2:** Vicinity Map



# Vicinity Map

34821 <u>Doheny Place</u> CDP19-0012



**Supporting Document 3**:

Site Photos









**Supporting Document 4**:

Color Rendering



Front (East) Elevation

Planning Commission Agenda Report CDP19-0012 October 14, 2019 Page 20

Supporting Document 5: Plans

ATTACHMENT

### RECEIVED

# BILLSTEIN RESIDENCE

DANA POINT, CALIFORNIA

CITY OF DANA POINT COMMUNITY DEVELOPMENT DEPARTMENT

GENERAL CITY NOTES:

ALL DRAWINGS SHALL BE IN ACCORDANCE WITH CBC, CRC AND CITY OF DANA POINT APPLICANT SHALL BE RESPONSIBLE FOR IMPROVEMENTS WITHIN ALL EXISTING UTILITY EASEMENTS ON PROPERTY.

3. ALL IMPROVEMENTS WITHIN THE PUBLIC RIGHT OF WAY REQUIRE A SEPARATE ENCROACHMENT

SEP 3 0 2019

### CONSTRUCTION WASTE: (2016 CALGREEN CODE)

RECYCLE AND/OR SALVAGE FOR REUSE A MINIMUM OF 65% OF THE NON-HAZARDOUS CONSTRUCTION AND DEMOLITION WASTE IN ACCORDANCE WITH EITHER SECTION 4.408.2. 4.408.3 OR 4.408.4. DOCUMENTATION IS REQUIRED PER SECTION 4.408.5.

EXCAVATED SOIL & LAND-CLEARING DEBRIS.

2. ALTERNATIVE WASTE REDUCTION METHODS DEVELOPED BY WORKING WITH LOCAL ENFORCING AGENCIES IF DIVERSION OR RECYCLE FACILITIES CAPABLE OF COMPLIANCE WITH THIS ITEM DO NOT EXIST OR ARE NOT LOCATED REASONABLY CLOSE TO THE JOBSITE.

3. THE ENFORCING AGENCY MAY MAKE EXCEPTIONS TO THE REQUIREMENTS OF THIS SECTION

WHEN ISOLATED JOBSITES ARE LOCATED IN AREAS BEYOND THE HAUL BOUNDARIES OF THE DIVERSION FACILITY

SUBMIT A CONSTRUCTION WASTE MANAGEMENT PLAN MEETING ITEMS 1 THROUGH 5 IN SECTION 4.408.2. PLANS SHALL BE UPDATED AS NECESSARY AND SHALL BE AVAILABLE FOR EXAMINATION DURING CONSTRUCTION.

UTILIZE A WASTE MANAGEMENT COMPANY, APPROVED BY THE ENFORCING AGENCY, WHICH CAN PROVIDE VERIFIABLE DOCUMENTATION THAT DIVERTED CONSTRUCTION AND DEMOLITION WASTE MATERIALS MEET THE REQUIREMENTS IN SECTION 4.408.1.

PROJECTS THAT GENERATE A TOTAL COMBINED WEIGHT OF CONSTRUCTION & DEMOLITION MASTE DISPOSED IN LANDFILLS, WHICH DO NOT EXCEED 3.4 POUNDS PER SQUARE FOOT OF THE BUILDING AREA, SHALL MEET THE MINIMUM 65% CONSTRUCTION WASTE REDUCTION REQUIREMENT IN SECTION 4.402.1.

**ABBREVIATIONS** 

	AND	E.	EAST	LAB.	LABORATORY
	ANGLE				
		EA.	EACH	LAM.	LAMINATE
	AT	E.D.F	DRINK FOUNTAIN	LAV.	LAVATORY
	CENTERLINE	E.J.	EXPANSION JOINT	LKR.	LOCKER
	DIAMETER OR ROUND	EL.	ELEVATION	LT.	LIGHT
	POUND OR NUMBER	ELEC.	ELECTRICAL		
)	EXISTING	ELEV.	ELEVATOR	MAX.	MAXIMUM
,	Bustine	EMER.	EMERGENCY		
				M.C.	MEDICINE CABINET
В.	ANCHOR BOLT	ENCL.	ENCLOSED	M.B.	MACHINE BOLT
3V.	ABOVE	E.P.	ELECTRICAL PANELBOARD	MECH.	MECHANICAL
COUS.	ACOUSTICAL	EQ.	EQUAL.	MEMB.	MEMBRANE
D.	AREA DRAIN	EGPT.	EQUIPMENT	MET.	METAL
2J.	ADJUSTABLE	EMC.	ELECTRIC WATER COOLER	MFG	MANUFACTURING
F.F.	ABOVE FINISH FLOOR				
		EXST.	EXISTING	MFR.	MANUFACTURER
SGR.	AGGREGATE	EXP.	EXPANSION	MH.	MANHOLE
	ALUMINUM	EXPO.	EXPOSED	MIN.	MINIMUM
JJM.	ALUMINUM	EXT.	EXTERIOR	MIR.	MIRROR
	ANGLE			MISC.	MISCELLANEOUS
PPROX.	APPROXIMATE	F.A.	FIRE ALARM		
RCH.	ARCHITECT			M.O.	MASONRY OPENING
		F.B.	FLAT BAR	MTD.	MOUNTED
RCH'L.	ARCHITECTURAL	F.D.	FLOOR DRAIN	MUL.	MULLION
SPH.	ASPHALT	FDN.	FOUNDATION		
		F.E.	FIRE EXTINGUISHER	N.	NORTH
		F.E.C.	FIRE EXTINGUISHER CABINET	N.I.C.	NOT IN CONTRACT
2.	BOARD			NO. OR #	NUMBER
		F.F.	FINISH FLOOR	NOM.	NOMINAL
TUM.	BITUMINOUS	F.G.	FINISH GRADE		
DG.	BUILDING	F.H.C.	FIRE HOSE CABINET	N.T.5.	NOT TO SCALE
K.	BLOCK	FIN.	FINISH		
KG.	BLOCKING	FL.	FLOOR	01	OVER
.T.	BOLT	FLASH.	FLASHING	O.A.	OVERALL
ч.	BEAM			OB5.	OBSCURE
		FLUOR.	FLUORESCENT	0.6.	ON CENTER
OT.	BOTTOM	F.O.C.	FACE OF CONCRETE		
		F.O.F.	FACE OF FINISH	OD.	OUTSIDE DIAMETER (DIM.)
AF3.	CABINET	F.O.M.	FACE OF MULLION	OFF.	OFFICE
В.	CATCH BASIN	F.O.S.	FACE OF STUDS	O.H.C.	OVERHEAD CABINET
EM.	CEMENT			OPNG.	OPENING
		FPRF.	FIREPROOF	OPP.	OPPOSITE
R.	CERAMIC	FRAM'G	FRAMING	OIT.	OFFOSITE
I.	CAST IRON	F.S.	FULL SIZE	100000000000000000000000000000000000000	
G.	CORNER GUARD	FT.	FOOT OR FEET	PROST.	FRECAST
G.	CEILING	FTG.	FOOTING	PL.	PLATE
KG.	CAULKING	FURR.	FURRING	P.LAM.	PLASTIC LAMINATE
0.	CLOSET			PLAS.	PLASTER
		FUT.	PUTURE	PLYND.	PLYWOOD
LR	CLEAR				
0.	CASED OPENING	GA.	GAUGE	PNL.	PANEL
OL.	COLUMN	GALY:	GALVANIZED	PTD.	PAINTED
ONC.	CONCRETE	G.B.	GRAB BAR	PLUMB.	PLUMBING
ONN.	CONNECTION	GL.	GLASS	PLYND.	PLYWOOD
				PL.	PROPERTY LINE
ONSTR.	CONSTRUCTION	GND.	GROUND	PR.	PAIR
ONT.	CONTINUOUS	GR.	GRADE		
O.F.	CORNER OF FINISH	GYP.	GYPSUM	PT.	POINT
ORR.	CORRIDOR	GYP BD	GYPSUM BOARD	PREFAB	PREFABRICATED
TSK.	COUNTERSUNK	G.B.	GYPSUM BOARD	P.T.D.	PAPER TOKEL DISPENSER
NTR.	COUNTER			P.T.D/R	COMBINATION PAPER TOWEL
		G.M.B.	GYPSUM WALL BOARD	1	DISPENSER 4 RECEPTAGLE
TR.	CENTER	H.B.	HOSE BIBB	PTN.	
					PARTITION
BL.	DOUBLE	H.C.	HOLLOW CORE	P.T.R.	PAPER TOWEL RECEPTAGLE
EPT.	DEPARTMENT	HDWD.	HARDWOOD	Q.T.	QUARRY TILE
F.	DRINKING FOUNTAIN	HDWE.	HARDWARE	G.1.	GOARST TILL
		H.M.	HOLLOW METAL	R.	RISER
ET.	DETAIL	HORIZ.	HORIZONTAL	RAD.	RADIUS
A.	DIAMETER				
M.	DIMENSION	HR.	HOUR	R	RADIU5
N.	DOWN	HT.	HEIGHT	R.D.	ROOF DRAIN
0.	DOOR OPENING	H.V.A.C	HEATING VENTILATING	REF.	REFERENCE
R.			AIR CONDITIONING	REFR.	REFRIGERATOR
	DOOR	HORZ	HORIZONTAL	REV	REVERSE
.S.	DOWNSPOUT	100000000000000000000000000000000000000	3000 (100) (1000 (100) (1000 (100) (1000 (1000 (100) (1000 (100) (1000 (100) (1000 (100) (1000 (100) (1000 (100) (1000 (100) (1000 (100) (1000 (100) (1000 (100) (1000 (100) (1000 (100) (1000 (100) (1000 (100) (100) (1000 (100) (100) (1000 (100) (1000 (100) (1000 (100) (100) (1000 (100) (100) (1000 (100) (100) (1000 (100) (100) (100) (100) (100) (100) (1000 (100) (	REINF	REINFORCE, REINFORCED
SP	DRY STANDPIPE			KEINE	NEINI ORGE, REINFORGED

### DESIGN DATA THIS PROJECT SHALL COMPLY WITH ALL REGULATIONS AND ORDINANCES ADOPTED BY THE LOCAL GOVERNING AGENCIE AS MELL AS THE FOLLOWING:

AS MELL AS THE FOLLOWING:

CODE: 2016 CALIFORNIA RESIDENTIAL CODE
2016 CALIFORNIA BUILDING CODE
2016 CALIFORNIA PLUMBING CODE
2016 CALIFORNIA MECHANICAL CODE
2016 CALIFORNIA MECHANICAL CODE
2016 CALIFORNIA ENERGY CODE
2016 CALIFORNIA ENERGY CODE
2016 CALIFORNIA GREEN BUILDING STANDARDS CODE
CITY OF DANA POINT AMENIMENTS

JURISDICTION:
CITY OF DANA POINT
ZONE:
REF-3 ZONE: RSF-3

CONSTRUCTION TYPE: OCCUPANCY: V-B (SPRINKLERED) R-3, U REQ'D: 10'-0" PROVIDED: 10'-0" SETBACKS: FRONT:

±5'-0" 25'-O" 25'-O"
BLUFF TOP SETBACK AS
ESTABLISHED BY GEOTECHNICAL
ENGINEER 28'-0" (ROOF PITCH: 6:12)

### LEGAL DESCRIPTION:

APN: 123-233-10
TRACT: 920
LOT: 10
GITY: DANA POINT
COUNTY: ORANGE

GROSS LOT AREA:

SOUTH
SOLID CORE
SEAT COVER DISPENSER
SEAT COVER DISPENSER
SOAP DISPENSER
SECTION
SQUARE FIET
SHICKE

SPACE
SPECIFICATIONS
SQUARE
SERVICE SINK
STAINLESS STEEL
STATICN
STAIDARD
STEEL
STORAGE
STRUCTURAL
STRUCTURAL
STRUCTURAL
STRUCTURAL
STRUCTURE
SUSPENDED
SOLID WOOD
SYMMETRICAL

TOMEL BAR
TOP OF CURB
TOP OF CURB
TELEPHONE
TELEPHONE
TERRAZIO
TOMGUE AND GROOVE
THICK
TOP OF CURB
TOP OF PARAFET
TOP OF PAVENT
TOLET PAPER DISPENSI
TREAD
TELEVISION
TELEVISION
TOP WALL
TYPICAL

UNFINISHED UNLESS OTHERWISE NOTED URINAL

VERTICAL VESTIBULE

WEST
WITH
WATER CLOSET
WOOD
WINDOW
WATER HEATER
WITHOUT
WATERPROOF
WAINSCOT
WEIGHT

9. C.D. S.C.D. S.C.D. S.C.D. S.C.D. S.C.D. S.C.T. S.F. SHR. SHR. SHR. SHR. S.C.D. S.C.

#### SQUARE FOOTAGE CALCULATIONS:

BASEMENT LIVABLE (EXIST'G) = BASEMENT LIVABLE (NEW) =	931.08 S.F. 65.98 S.F.
TOTAL BASEMENT LIVABLE =	∧ 997.06 S.F.
FIRST FLOOR LIVABLE (EXIST'G) = FIRST FLOOR LIVABLE (NEW) =	2524.37 S.F. 95.01 S.F.
TOTAL FIRST FLOOR LIVABLE =	2619.38 S.F.
TOTAL LIVABLE =	A 3616.44 S.F.
GARAGE (EXIST'G) = GARAGE (NEW) =	447.06 S.F. 44.25 S.F.
TOTAL GARAGE =	A 491.31 S.F.
DECK (EXIST'G) = DECK (NEW) =	1072.97 S.F. 208.03 S.F.
TOTAL DECK =	1281.00 S.F.
TOTAL STRUCTURE = LOT COVERAGE:	5388.75 S.F.
LOT AREA = BUILDING COVERAGE =	15,681.60 S.F. 4504.82 S.F.
LOT COVERAGE (35% MAX.) = LANDSCAPE COVERAGE:	29%
( LOT AREA = LANDSCAPE AREA =	15,681.60 S.F. 5939.82 S.F.

DEFERRED SUBMITTALS:

(2016 CBC CHAPTER 1 DIVISION II, SECTION 107.3.4.1)

FOR REVIEW BY THE BUILDING OFFICIAL.

DEFERRED SUBMITTALS:

FIRE SPRINKLERS

# RENOVATION OF EXISTING RESIDENCE, NEW ROOF STRUCTURE, INTERIOR REMODEL, NEW ARCHITECTURAL STYLE, ADDITION OF NEW COVERED LOGGIA OVER EXISTING REAR DECK, REMOVE & REPLACE EXISTING REAR DECK MATERFROOFING & GUARDRAIL, ADD 2 NEW DECKS AT BACK OF HOUSE, ADD 127 S.F. OF NEW VASILE AREA IN THE BACKFURT AND RASE OF NEW

PROJECT SCOPE:

NABLE AREA ON THE FIRST FLOOR.

PROJECT TEAM:

SURVEYOR:

STRUCTURAL ENGINEER:

15,681.60 S.F.

BETH BILLSTEIN 34821 DOHENY PLACE DANA POINT, CA 92624

GEOTECHNICAL: GEOFIRM BO1 GLENNEYRE ST., SUITE F LAGINA BEACH, CA 92651 PHONE: (949) 494-2122 FAX: (449) 494-2122 CONTACT: KEYN TOGG EMAIL: KITIGGGOFIRM.com

CONTACT: BRIAN MUEHLBAUER

GOUVIS ENGINEERING
15 STUDEBAKER
IRVINE, CA 42616
PHONE: (494) 152-1612
FAX: (494) 152-5321
CONTACT: MIKE HOUSHMAND
EMAIL: mhoushmand@gouvisgro

15 STUDEBARER IRVINE, CA 92616 PHONE: (949) 752-1612 FAX: (949) 752-5321 CONTACT: MIKE HOUSHMAND EMAIL: mhoushmand@gouvisgroup.com

PROJECT NOTES: POOLS, SPAS, WALLS, FENCES, PATIO COVERS, FIRE PITS & OTHER FREESTANDING STRUCTURES REQUIRE SEPARATE REVIEWS AND PERMITS. PROVIDE PORTABLE TOILET AND HAND WASH

IVABLE AREA IN THE BASEMENT AND 84 S.F. OF NEW

### PLUMBING FIXTURES:

DEFERRAL OF ANY SUBMITTAL ITEMS SHALL HAVE PRIOR APPROVAL OF THE BUILDING OFFICIAL. THE REGISTERED DESIGN PROFESSIONAL IN RESPONSIBLE CHARGE SHALL LIST THE DEFERRED SUBMITTALS ON THE CONSTRUCTION DOCUMENTS ON & AFTER JANUARY 1, 2014, RESIDENTIAL BUILDINGS FOR REVIEW BY THE BUILDING OFFICIAL.

DOCUMENTS FOR DEFERRED SUBMITTAL ITEMS SHALL BE

SUBMITTED TO THE REGISTERED DESIGN PROFESSIONAL IN

RESPONSIBLE CHARGE WHO SHALL REVIEW THEM AND FORWAR

THEM TO THE BUILDING OFFICIAL MITH A NOTATION INDICATING

THAT THE DEFERRED SUBMITTAL DOCUMENTS HAVE BEEN LUMBING FIXTURES WITH WATER-CONSERVING PLUMBING FATURES. PLUMBING FIXTURE REPLACEMENT IS REQUIRED PRIOR TO ISSUANCE OF A CERTIFICATE OF FINAL COMPLETION, CERTIFICATE OF COLONIAL OF THE LOCAL BUILD'S OR FINAL PRIMIT APPROVAL BY THE LOCAL BUILD'S DEPARTMENT. A CERTIFICATE OF COMPLIANCE FOR THAT THE DEFERRED SUBMITIAL DOCUMENTS HAVE BEEN REVIEWED AND FOUND TO BE IN GENERAL CONFORMANCE TO THE DESIGN OF THE BUILDING. THE DEFERRED SUBMITIAL ITEMS SHALL NOT BE INSTALLED UNTIL THE DEFERRED SUBMITIAL INCLUMENTS HAVE BEEN APPROVED BY THE BUILDING OFFICIAL. DEFERRED SUBMITIALS SHALL BE IN ACCORDANCE WITH CALIFORNIA ADMINISTRATIVE CODE, CHAPTER T, SECTION 7-126. ATER CONSERVING PLUMBING FIXTURES WILL BE EQUIRED AT FINAL INSPECTION.

### FIRE SPRINKLERS:

FIRE SPRINKLER SYSTEM CONFORMING TO THE LATEST N.F.P.A. 13D STANDARD SHALL BE INSTALLED DESIGN UNDER SEPERATE SUBMITTAL

### SHEET INDEX

ARCHITECTURE
T-1 TITLE SHEET
C-1 TOPOGRAPHIC SURVEY
A-1. ARCHITECTURAL SITE PLAN
A-2.1 ARCHITECTURAL SITE PLAN
A-2.1 AS-BUILT / DEMO BASEMENT FLOOR PLAN
A-3.1 AS-BUILT / DEMO BASEMENT FLOOR PLAN
A-3.1 AS-BUILT / DEMO FIRST FLOOR PLAN
A-3.1 AS-BUILT / DEMO FIRST FLOOR PLAN
A-3.2 DEMOLITION CALCULATIONS
A-4 NORTH & SOUTH EXTERIOR ELEVATIONS
A-5 EAST & WEST EXTERIOR ELEVATIONS
A-6 SECTIONS A & B STUDIO 6 ARCHITECTS, INC. 2753 CAMINO CAPISTRANO, SUITE A-100 SAN CLEMENTE, CA 92672 PHONE: (949) 368-5300 FAX: (949) 368-3330 

AS-BUILT / DEMO ROOF PLAN RENDERED FRONT ELEVATION

# ENC SIDI Ш $\overline{\mathbf{x}}$

BILLSTEIN 34821 DOHENY PLACE DANA POINT, CA

Studio/

PROJECT CONTACT:

PROJECT TEAM:

PRINCIPAL DESIGN ARCHITECT:

CLIENT:

HONE NUMBER

FAX NUMBER

PHONE: (949) 388-5300

brian@studio6architects.com

FAX: (949) 388-333

ROBERT WILLIAMS

PROJECT NUMBER:

### 2018016

MILESTONES / REVISIONS 4.5.19 DD MEETING ↑ 9.5.19 CDP SUB. #2

SOUNCE OF A BUILDING PERMIT BY THE COUNTY OF ORANGE DOES NOT RELIEVE APPLICANTS OF THE LEGAL REQUIREMENTS TO OBSERVE COVENANTS, CONDITIONS AND RESTRICTIONS WHICH MAY BE RECORDED AGAINST THE PROPERTY OR TO OSTAIN PLANS, TOU SHOULD CONTACT YOUR COMMUNITY ASSOCIATIONS PRICR TO COMMENCEMENT OF ANY CONSTRUCTION AUTHORIZED BY THE PERMIT.





SHEET TITLE

TITLE SHEET

SHEET NUMBER

ICENSE STAMP

T-1

### PROJECT NOTES:


- POOLS, SPAS, WALLS, FENCES, PATIO COVERS, FIRE PITS AND OTHER FREESTANDING STRUCTURES REQUIRE SEPARATE REVIEWS AND PERMITS.
- PROVIDE PORTABLE TOILET & HAND WASHING STATION PER OSHA REGULATIONS.


I.D. INSUL. INT.


### GENERAL CONTRACTOR / SUBCONTRACTOR RESPONSIBILITY:

- ALL POTENTIAL DESIGN, ENGINEERING AND SPECIFICATION CHANGES PROPOSED DURING CONSTRUCTION ARE REQUIRED TO BE PRESENTED TO AND APPROVED BY THE ARCHITECT PRIOR TO IMPLEMENTING CHANGES. 2. GENERAL CONTRACTOR AND ALL SUBCONTRACTORS ARE TO REVIEW AND BECOME FAMILIAR WITH THE ENTIRE SET OF CONSTRUCTION DOCUMENTS, INCLUDING BUT NOT LIMITED TO ARCHITECTURAL & STRUCTURAL DETAILS, REFLECTED CEILING PLANS, ELECTRICAL PLANS AND
- SCHEDULES, PRIOR TO BIDDING AND CONSTRUCTION.


  3. GENERAL CONTRACTOR IS RESPONSIBLE TO ENSURE ALL SUBCONTRACTORS BIDDING & CONTRACTED TO PERFORM WORK OR SUPPLY MATERIALS HAS RECEIVED AN ENTIRE SET OF CONSTRUCTION DOCUMENTS FOR THIS PROJECT.
- 4. GENERAL CONTRACTOR IS RESPONSIBLE TO ENSURE ONLY COPIES OF THE CITY AND/OR COUNTY APPROVED CONSTRUCTION DOCUMENTS ARE ON SITE AND USED FOR CONSTRUCTION. BID SETS ARE ALLOWED FOR CONSTRUCTION.

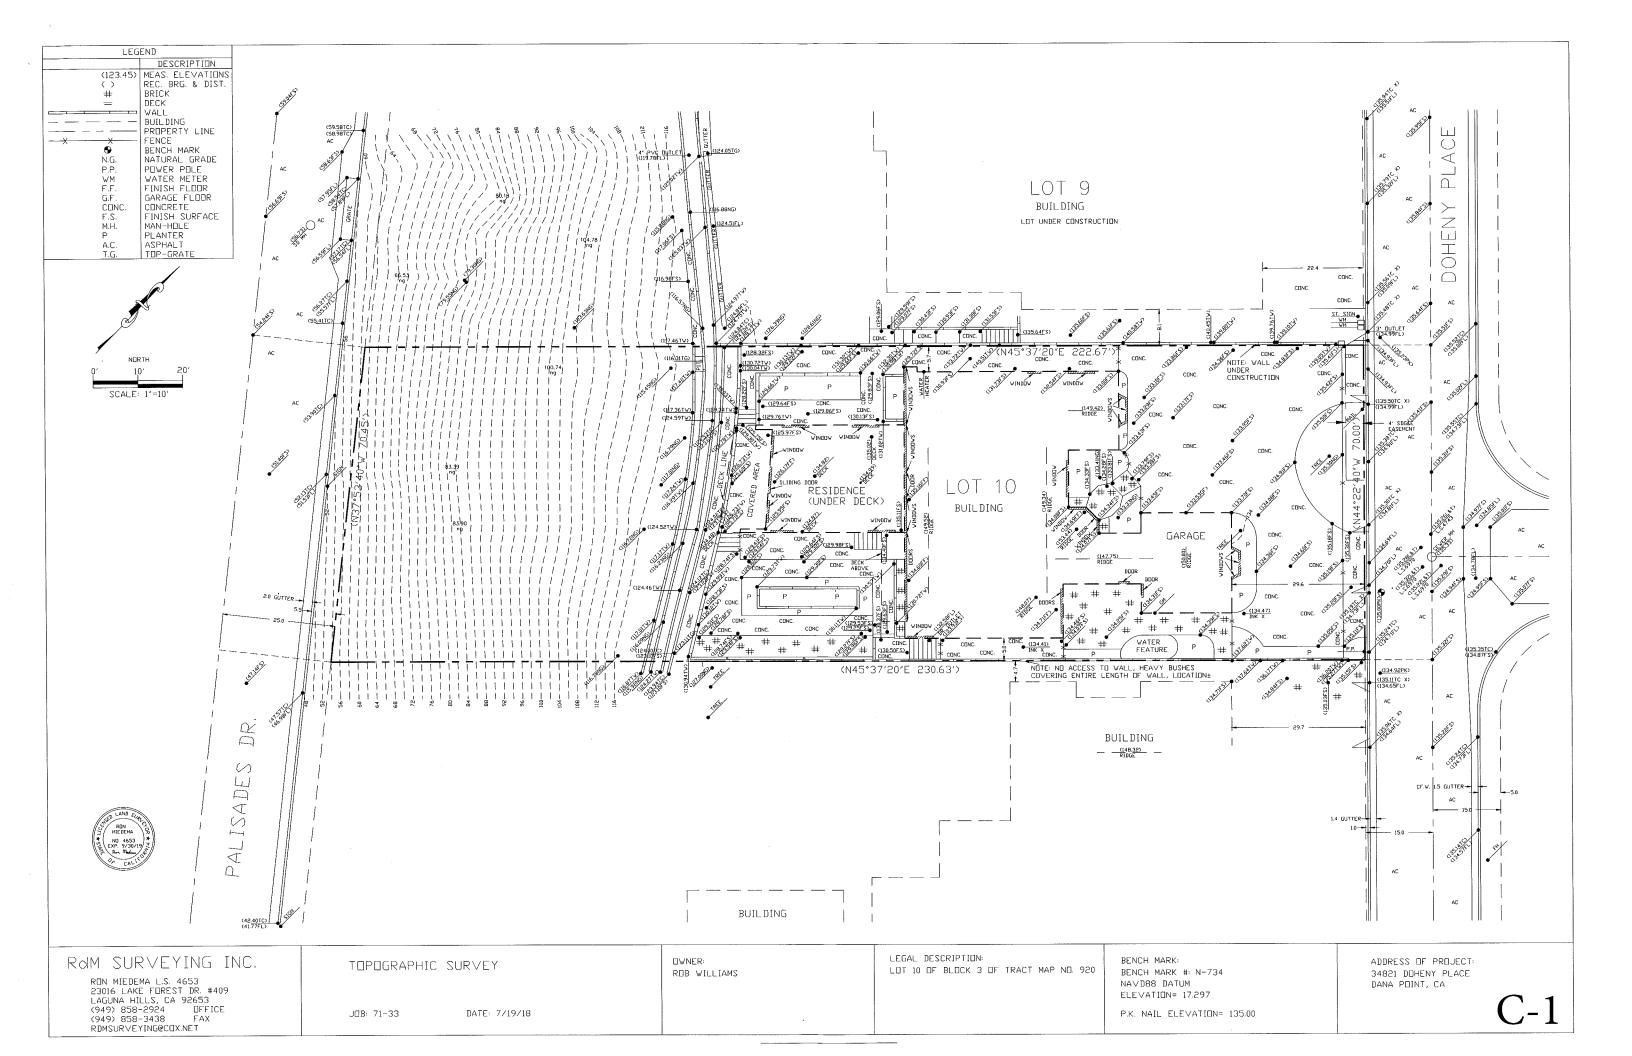

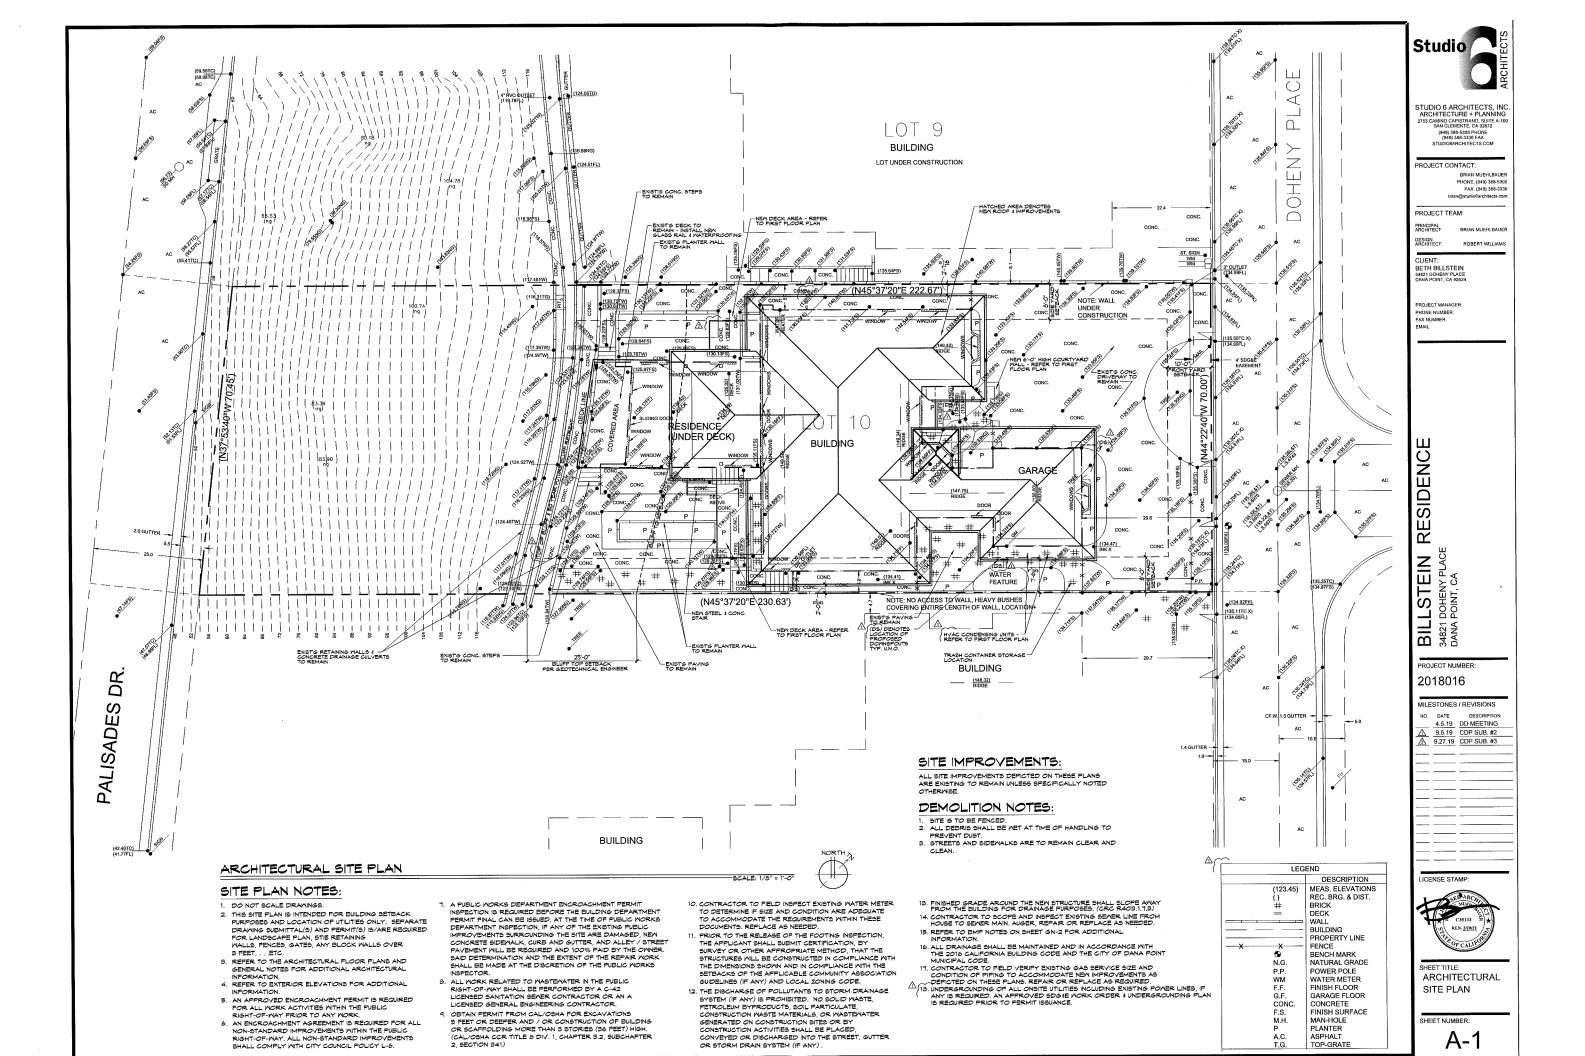


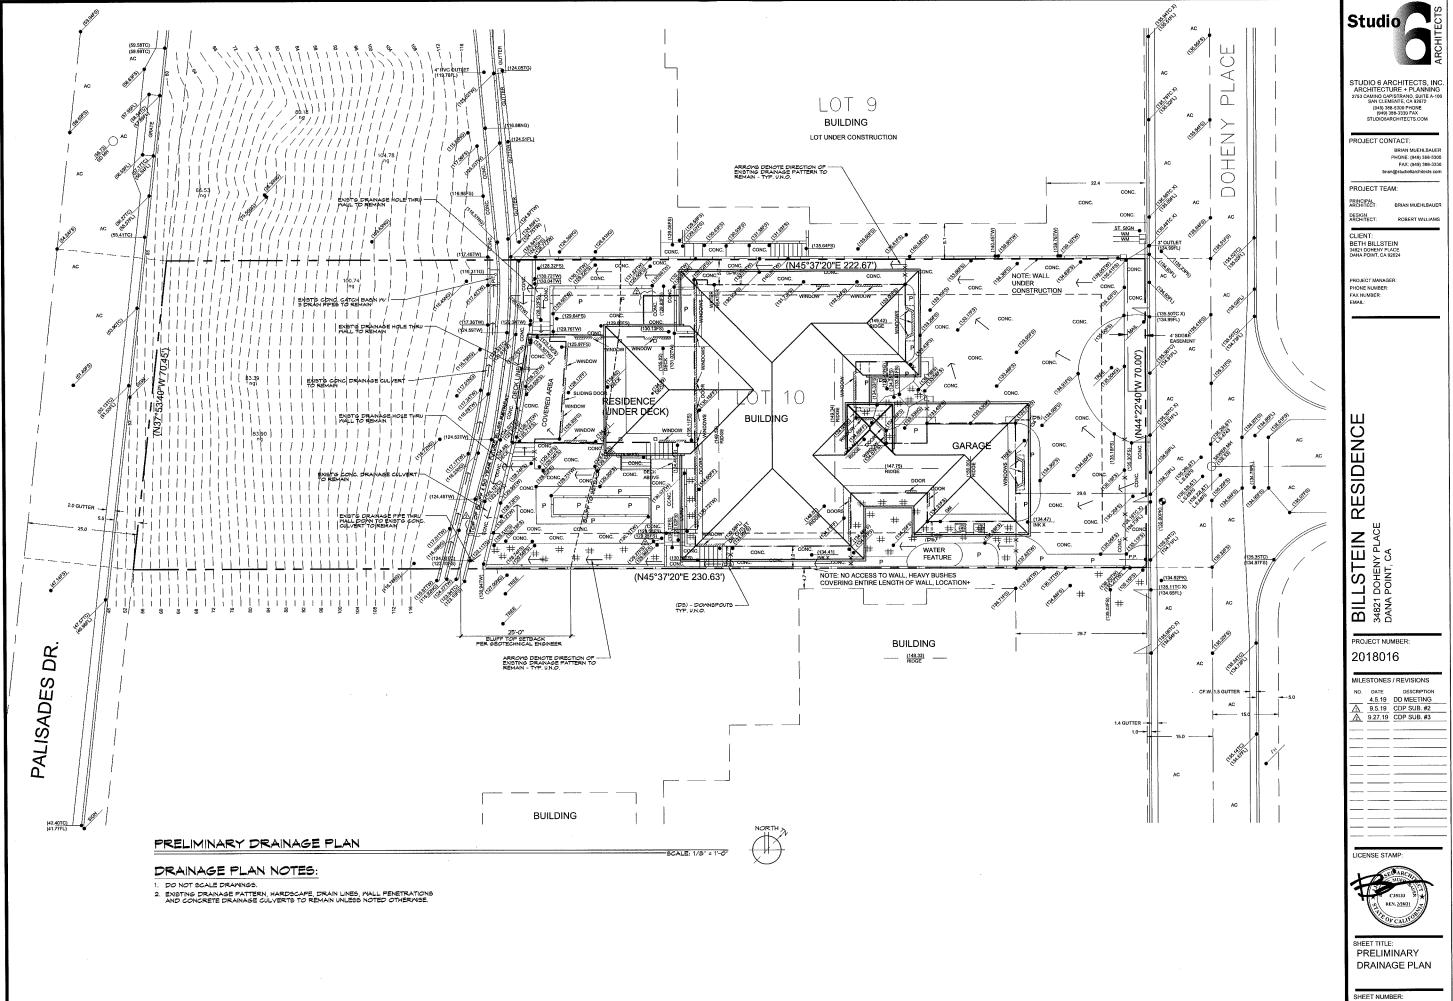


A-1.1

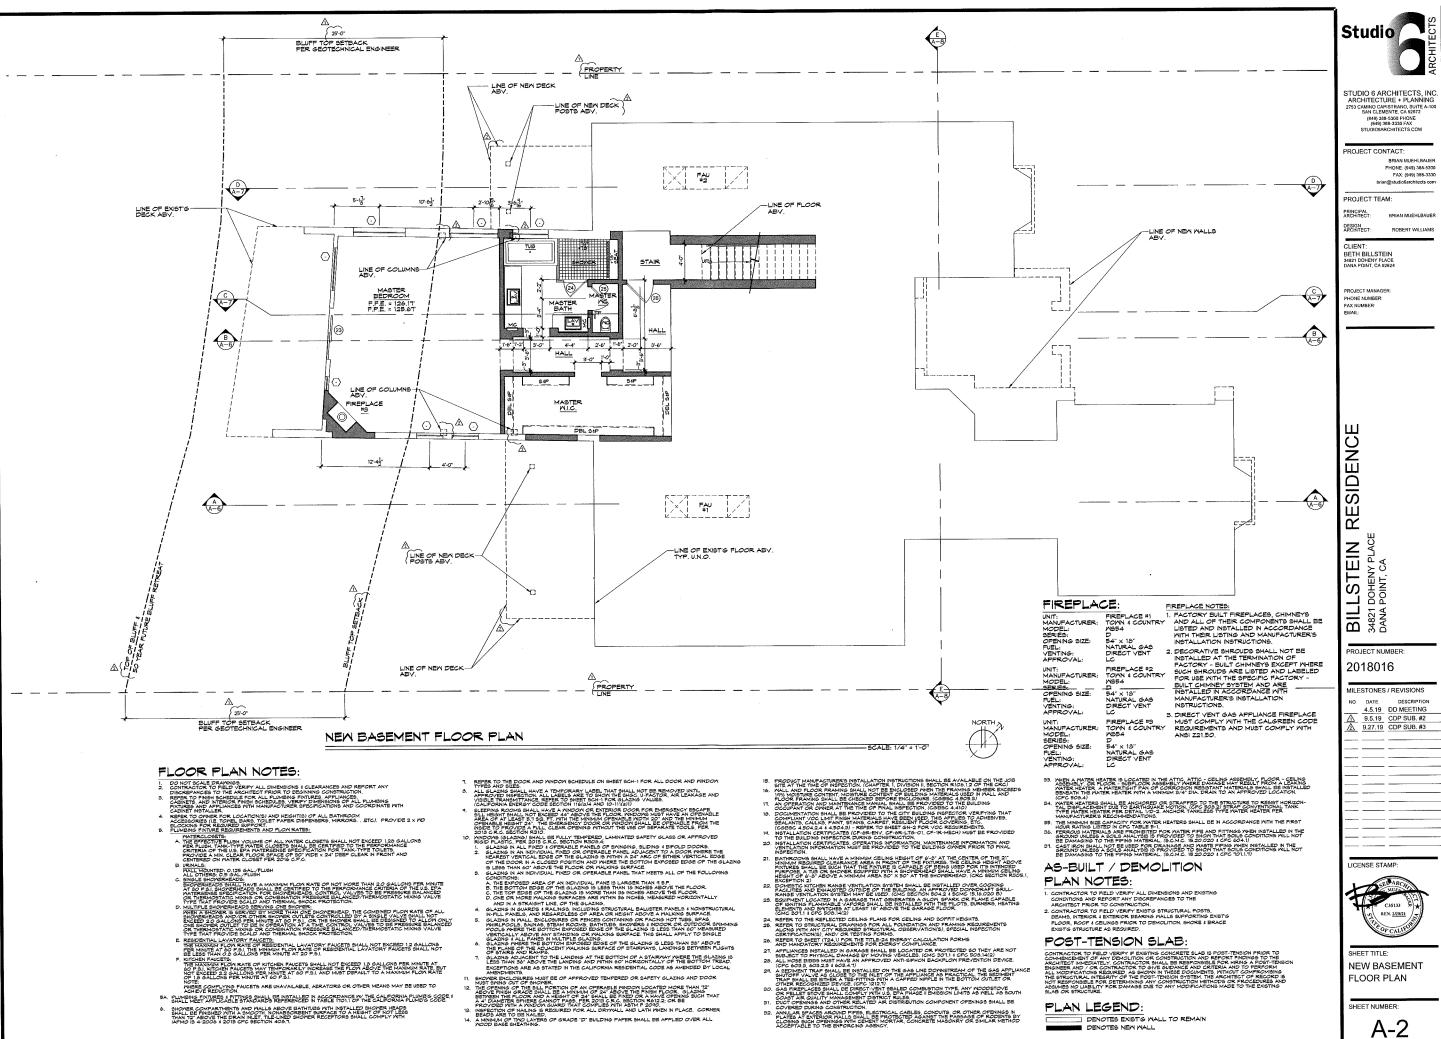

A-2

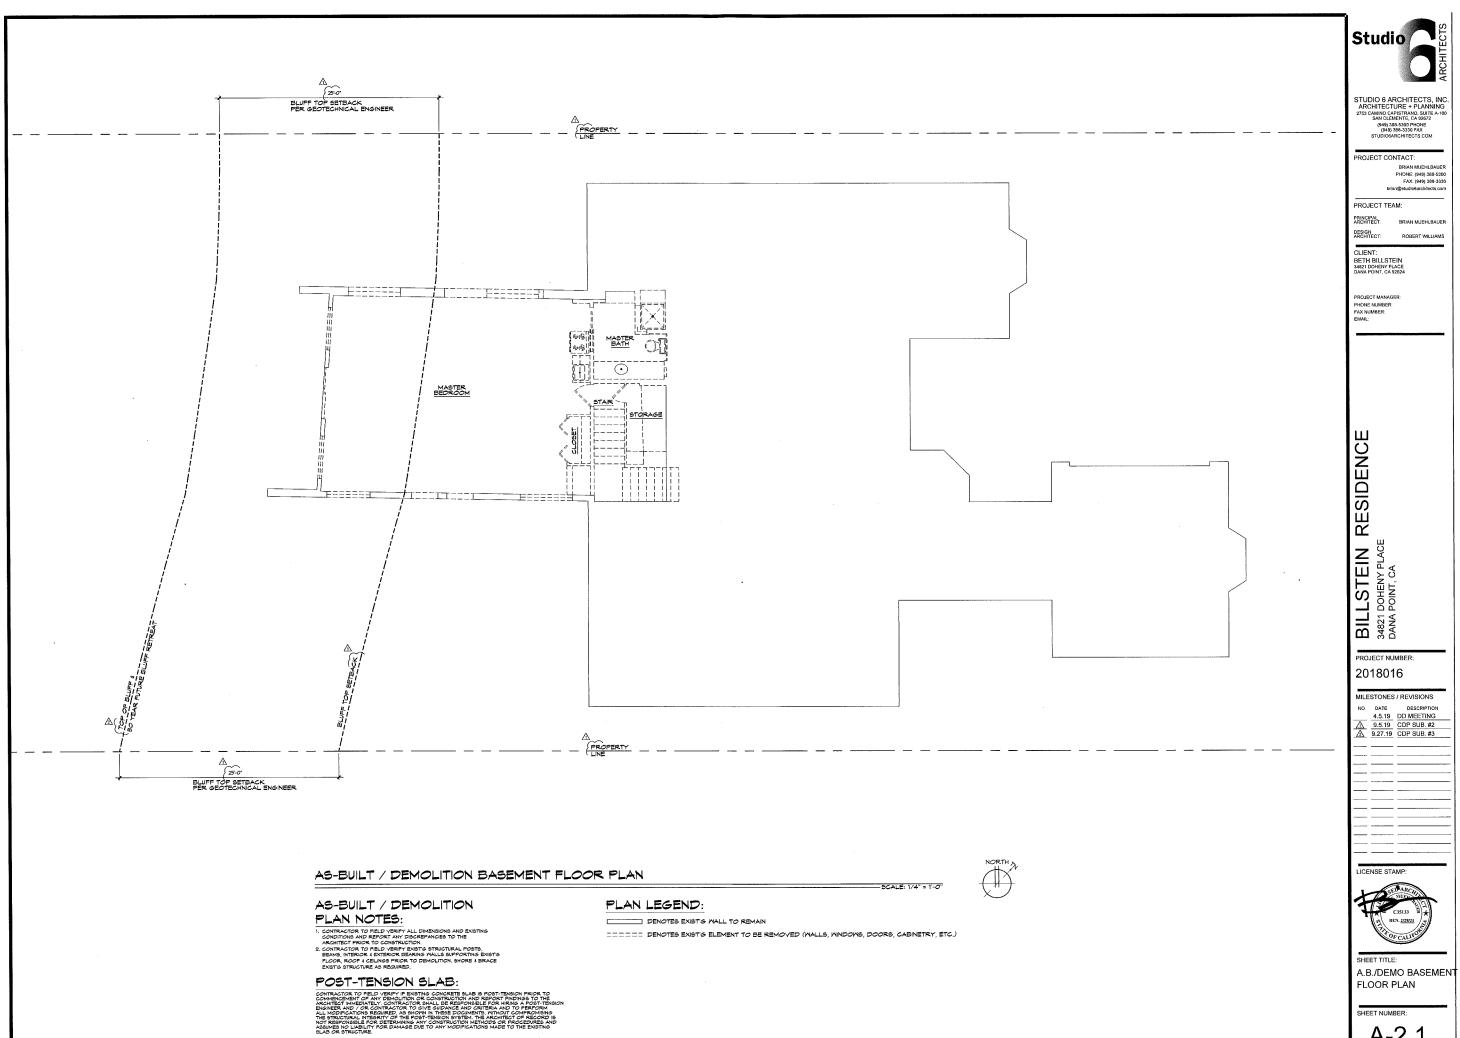

A-2.1

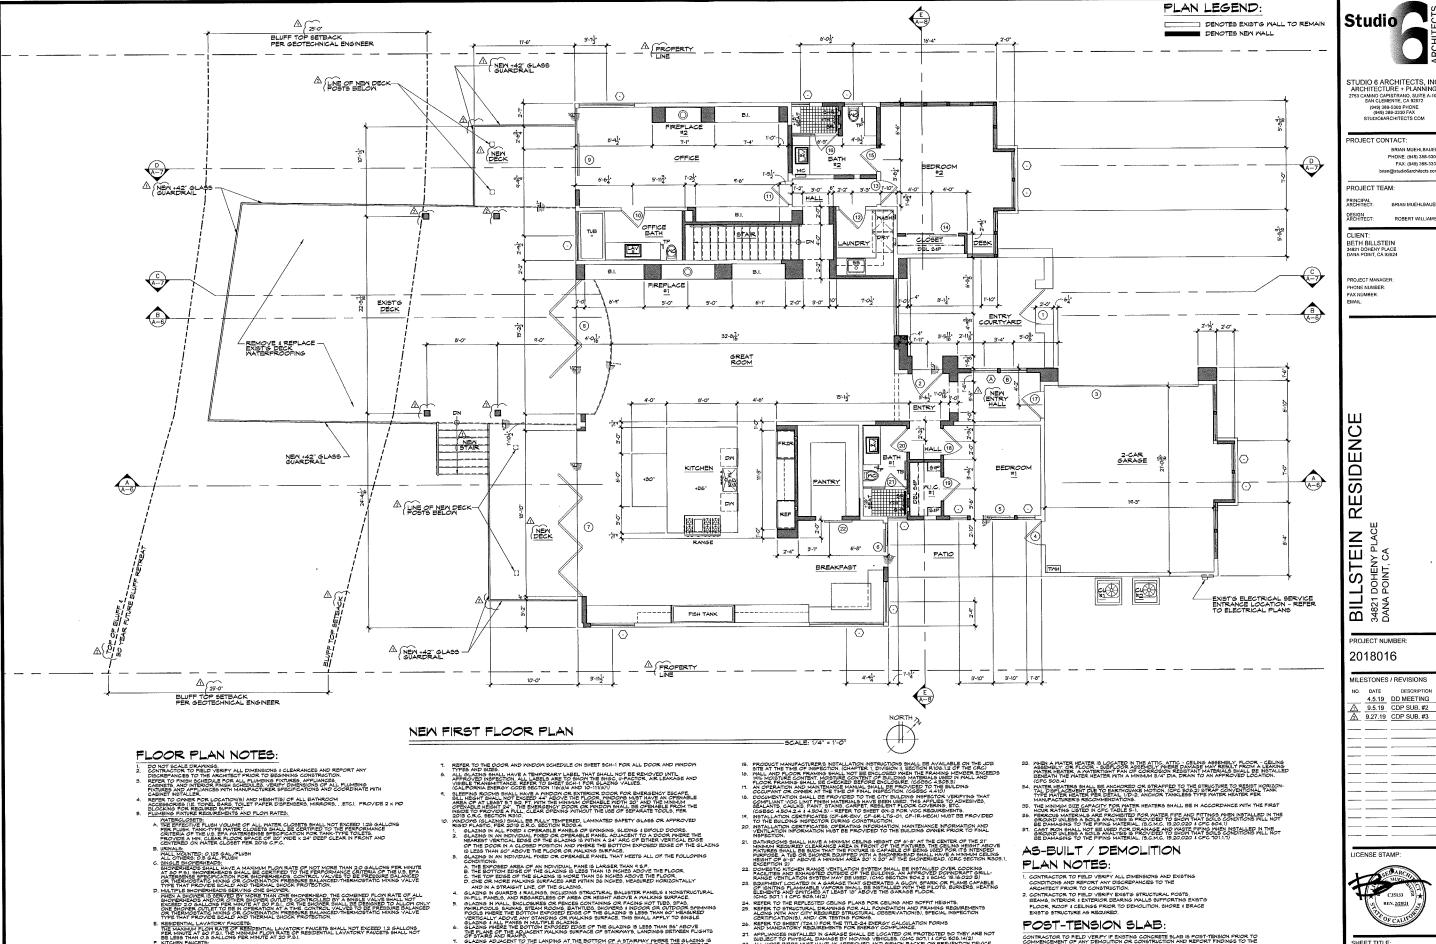

OF 2 INING ADJACENT TO THE LANDING AT THE BOTTOM OF A STAIRWAY PAERE THE GLAZING IB LESS THAN 36" ABOVE THE LANDING AND MITHIN 60" HORIZONTALLY OF THE BOTTOM TREAD. EXCEPTIONS ARE AS STATED IN THE CALIFORNIA RESIDENTIAL CODE AS AMENDED BY LOCAL

AMENDMENTS.

SHOWER ENCLOSURES MUST BE OF APPROVED TEMPERED OR SAFETY GLAZING AND DOOR MUST SYNNG OUT OF SHOWER. MUST SINK OUT OF BROKEN APPROVED TEMPERED OR SAFETY GLAZING AND DOOR MUST SINKS OF THE SILL PORTON OF AN OPERALE NATURAL SOMETHING OF THE SILL PORTON OF AN OPERALE NATURE PRICE THAT OF SIZE AND STATEMENT OF THE PRICE AND A RESENT OF THE PRICE AND A RESENT OF THE PRICE AND A RESENT OF THE PRICE OF THE PRICE OF THE SIZE OF THE SIZ

DEADS AND TO BE NAILED.

A MINIMUM OF TWO LAYERS OF GRADE 'D' BUILDING PAPER SHALL BE APPLIED OVER ALL WOOD BASE SHEATHING.

TYPE THAT PROVIDE SCALD AND THERMAL SHOCK PROTECTION.

RESIDENTIAL LAVATORY PAUCETS.

THE MAXIMUM PLOW RATE OF RESIDENTIAL LAVATORY FAUCETS SHALL NOT EXCERD 12 GALLONS
THE MAXIMUM PLOW RATE OF RESIDENTIAL LAVATORY FAUCETS SHALL NOT
BELLESS THAN 0.5 GALLONS PER MINITE AT 20 P.S.I. EXPENDITIAL LAVATORY FAUCETS SHALL NOT
FER MAXIMUM CONTRACTS OF MINITE AT 20 P.S.I. EXPENDITIAL LAVATORY FAUCETS SHALL NOT EXCERD 1.6 GALLONS PER MAXIMUM RATE BUT
AND TRACETS.

THE MAXIMUM PROVINCETS AND TEMPORATELY INCREES THE FLOW ABOVE THE MAXIMUM RATE BUT
AND EXCERD 2.2 GALLONS PER NINUTE AT 20 P.S.I. AND MIST DEFAULT TO A MAXIMUM FLOM RATE
OF THE MAXIMUM PLOW RATE SHALL NICE SET THE PLOY ABOVE THE MAXIMUM RATE BUT
AND THE MAXIMUM PLOY RATE OF THE MAXIMUM PLOY RATE
OF THE MAXIMUM PLOY RATE
OF THE MAXIMUM PLOY RATE
OF THE MAXIMUM PLOY RATE PLOY RATE
OF THE MAXIMUM PLOY RATE
OF THE

NO IC: WHERE COMPLYING FAUCETS ARE UNAVAILABLE, AERATORS OR OTHER MEANS MAY BE USED TO ACHIEVE REDUCTION

5A. PLUMBING FIXTURES & FITTINGS SHALL BE INSTALLED IN ACCORDANCE W THE CALIFORNIA PLUMBIG CODE. SHALL MEET APPLICABLE STANDARDS REFERENCED IN TABLE 1101.1 OF THE CALIFORNIA PLUMBIG CODE.

SHOWER COMPARTMENTS AND WALLS ABOVE BATHTURS WITH INSTALLED SHOWER HEADS SHALL BE PRINGHED WITH A SMOOTH, NONABSORBERT BURFACE TO A HEIGHT OF NOT LESS THAN 12' ABOVE THE DRAIN INLET. TILE-LINED SHOWER RECEPTORS SHALL COMPLY WITH LAPAUS 14 2006 12 013 CPC SECTION 408.T.

Studio/

STUDIO 6 ARCHITECTS, INC

ROJECT CONTACT:

BRIAN MUEHLBAUE PHONE: (949) 388-5300 FAX: (949) 388-3330

ROBERT WILLIAMS

PROJECT NUMBER

MILESTONES / REVISIONS

NEW FIRST

FLOOR PLAN

A-3

POST-TENSION SLAB:

REFER TO SHEET (124.1) FOR THE TITLE-24 ENERGY CALCULATION FORMS AND MANDATORY REQUIREMENTS FOR ENERGY COMPLIANCE.

40. THE TANKS STOCKY LIGHTLESS THE STATE STATES CALLADIATION FOR MS
AND TANKS STOCKY LIGHTLESS THE STATES OF THE CALLADIATION FOR THE TOP AND THE STATES

21. THE TANKS STATES AND THE STATES OF THE S


COVERED DURING CONSTRUCTION.

92. ANNILAR SPACES ARCAND PIPES, ELECTRICAL CABLES, CONDUITS OR OTHER OPENINGS TO PLATES AT EXTERIOR PRALES SHALL BE PROTECTED AGAINST THE PAGASAS OF RODDENS BY CLOSING SUCH OPENINGS WITH CEMENT MORTAR. CONCRETE MASONRY OR SIMILAR METHOD ACCEPTABLE TO THE BIRDOCKING ASSINCT

CONTRACTOR TO FIELD VERIFY IF ENSITING CONCRETE SLAB IS POST-TENSION PRIOR TO COMMENCEMENT OF ANY DEMOLITION OR CONSTRUCTION AND REPORT FINDINGS TO THE ARCHITECT INVESTIGATION AND REPORT FINDINGS TO THE ARCHITECT INVESTIGATION AND REPORT FINDINGS TO THE ARCHITECT INVESTIGATION AS PROVING THE RESPONSIBILE FOR MINION A POST-TENSION AND ARCHITECTURE AS SHOWN IN THESE PROCUMENTS, WITHOUT COMPREDIGATION OF THE ARCHITECT OF THE POST-TENSION SYSTEM THE ARCHITECT OF RECORD NOT RESPONSIBLE FOR DETERMINED ANY CONSTRUCTION METHODS OR PROCEDURES AS A SECOND AND A POST-TENSION AND TO THE MINISTRUCTURE AND ARCHITECTURE AND A

### KITCHEN EXHUST HOOD:

A KITCHEN EXHAUST WITH A MINIMUM RATE OF 100 CFM AND A MAXIMUM SOUND RATING OF 3 SONE FOR INTERMITTENT OPERATION IS REQUIRED. THE KITCHEN HOOD SHALL BE DUCTED TO THE OUTSIDE REGARDLESS OF FUEL OR HOOD

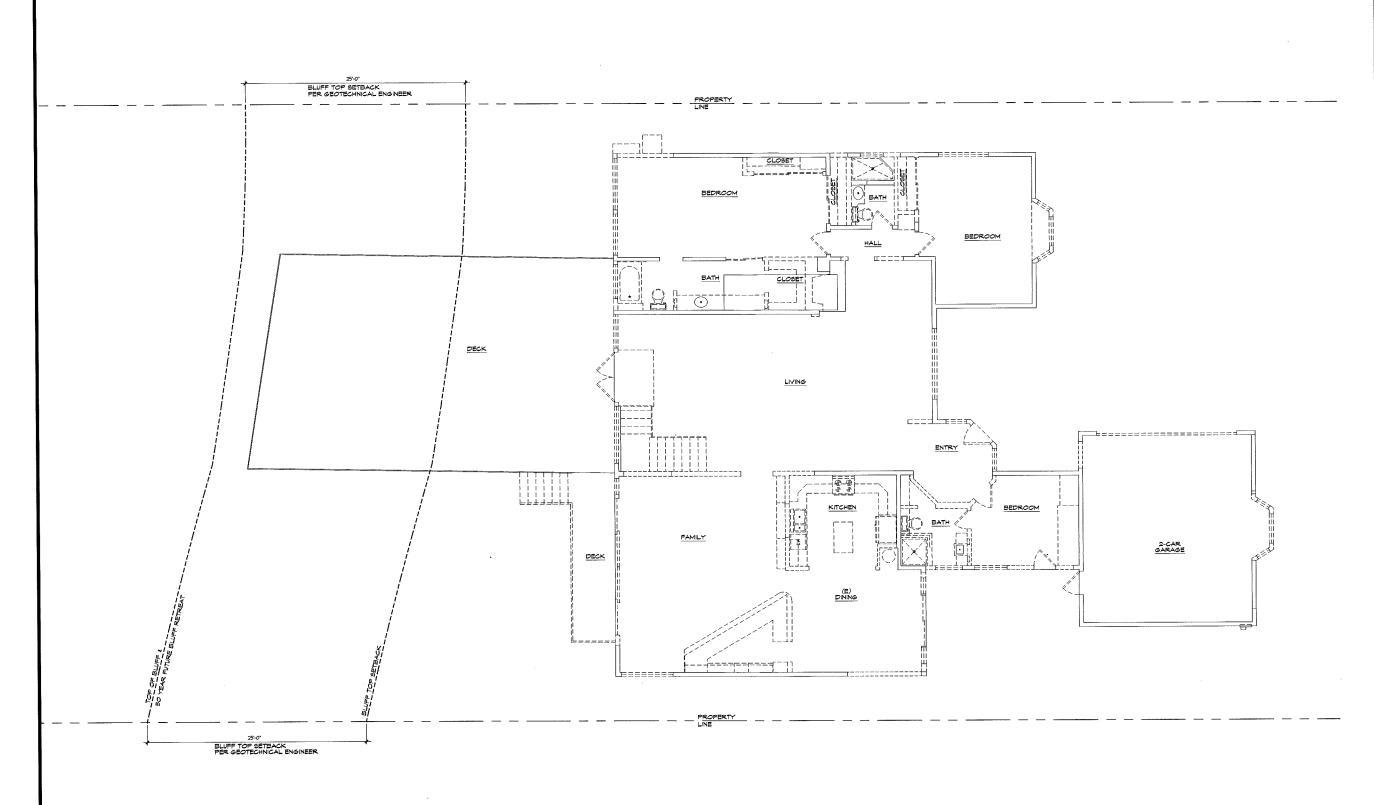

### AS-BUILT / DEMOLITION FIRST FLOOR PLAN

-SCALE: 1/4" = 1'-0"

### AS-BUILT / DEMOLITION PLAN NOTES:

- 1. CONTRACTOR TO PIELD VERIFY ALL DIMENSIONS AND EXISTING CONDITIONS AND REPORT ANY DISCREPANCES TO THE ARCHITECT PRIOR TO CONSTRUCTION.
  2. CONTRACTOR TO FIELD VERIFY ENSITE STRUCTURAL POSTS. BEAMS, INTERIOR & EXTENDED BEAMS AND THE RESIDENCE AND THE STRUCTURE AS REQUIRED.

### POST-TENSION SLAB:



### PLAN LEGEND:

\_\_\_\_ DENOTES EXIST'G WALL TO REMAIN

===== DENOTES EXIST'S ELEMENT TO BE REMOVED (WALLS, WINDOWS, DOORS, CABINETRY, ETC.)



STUDIO 6 ARCHITECTS, INC. ARCHITECTURE + PLANNING 2753 CAMINO CAPISTRANO, SUITE +-100 SAN CLEMENTE, CA 92672 (949) 388-5300 PHONE (949) 388-3330 FAX STUDIOBARCHITECTS COM

PROJECT CONTACT:

BRIAN MUEHLBAUER PHONE: (949) 388-5300 FAX: (949) 388-3330 brian@studio6architects.com

PROJECT TEAM:

PRINCIPAL ARCHITECT:

DESIGN ARCHITECT: ROBERT WILLIAMS

CLIENT: BETH BILLSTEIN 34821 DOHENY PLACE DANA POINT, CA 92624

PROJECT MANAGER PHONE NUMBER: FAX NUMBER: EMAIL:

BILLSTEIN RESIDENCE 34821 DOHENY PLACE DANA POINT, CA

PROJECT NUMBER: 2018016

MILESTONES / REVISIONS

NO. DATE DESCRIPTION
4.5.19 DD MEETING
9.5.19 CDP SUB. #2
9.27.19 CDP SUB. #3


LICENSE STAMF



SHEET TITLE: A.B./DEMO 1ST FLOOR PLAN

SHEET NUMBER:


A-3.1

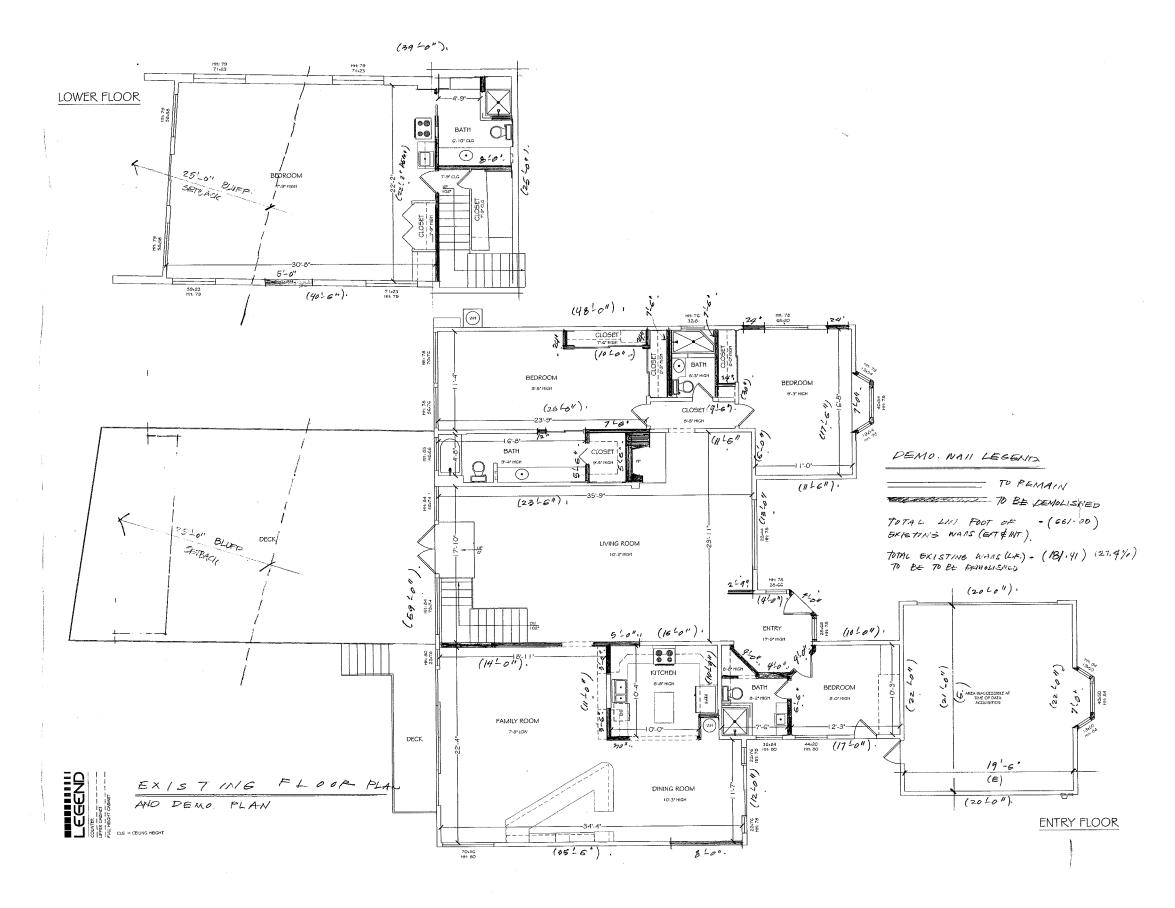




DANA POINT, CALIFORNIA



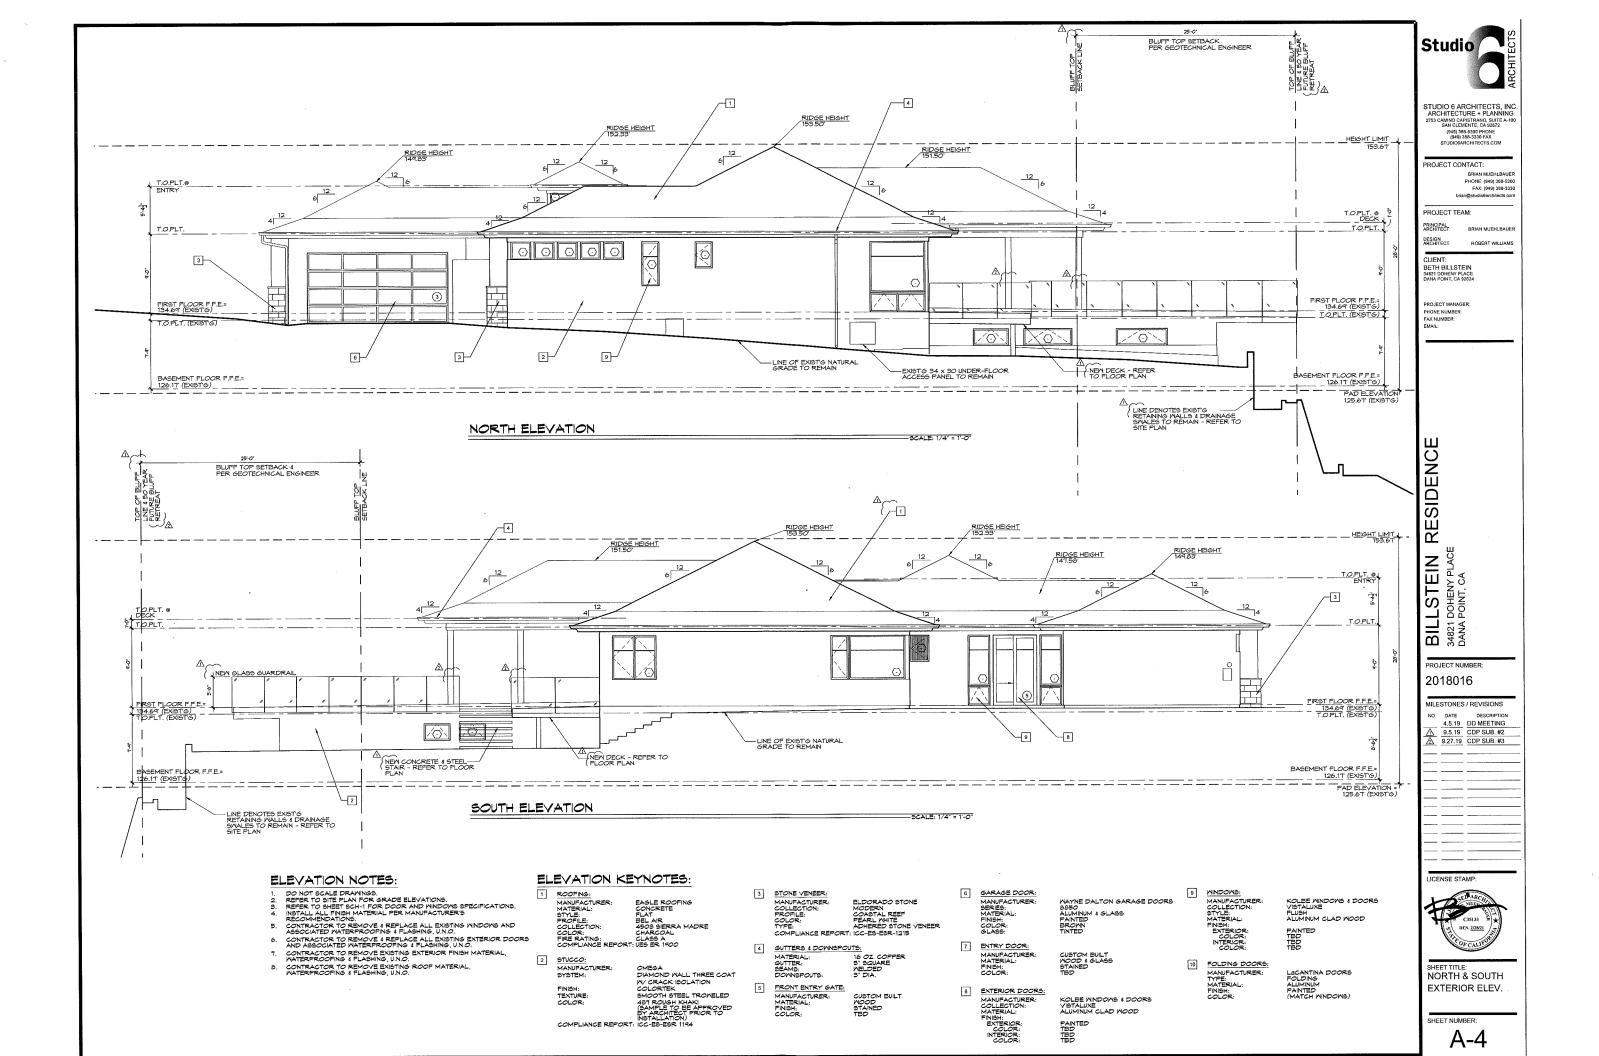

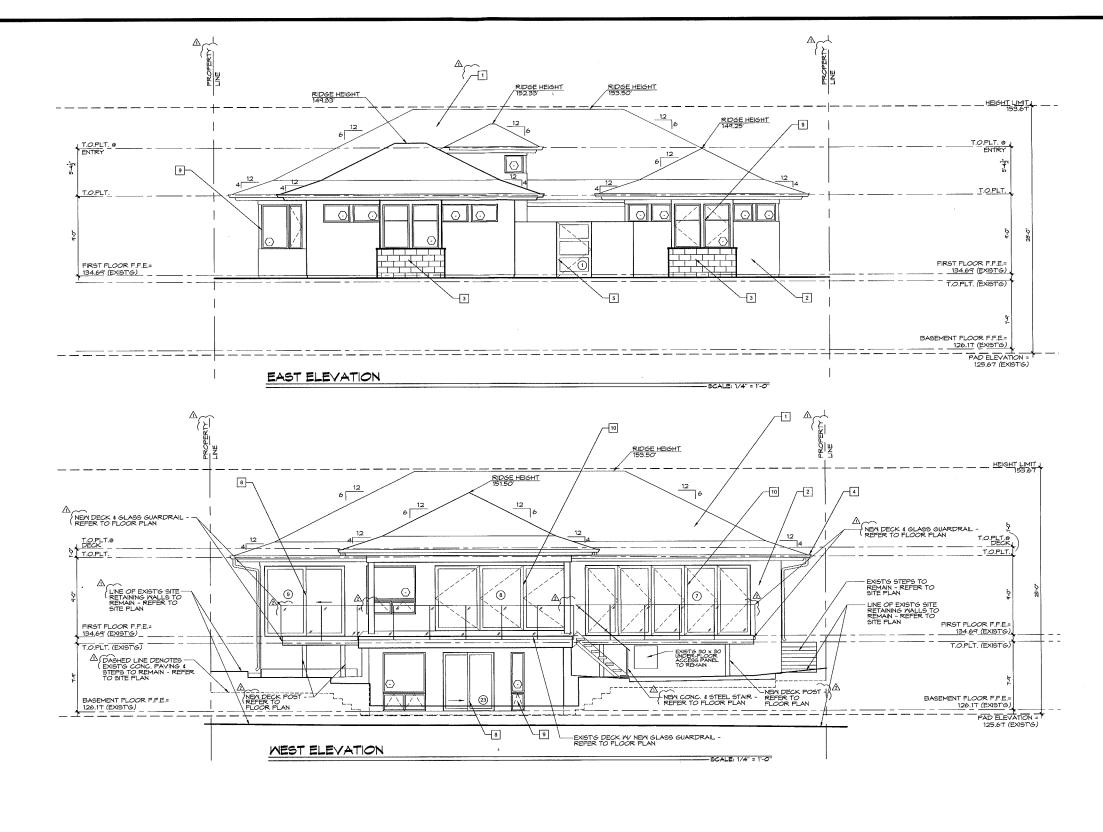

### ELEVATION NOTES:

- DO NOT SCALE DRAWINGS.
  REFER TO SITE PLAN FOR GRADE ELEVATIONS.
  REFER TO SHEET SCH-I FOR DOOR AND NINDOWS SPECIFICATIONS.
  INSTALL ALL FINISH MATERIAL PER MANUFACTURERS'
  RECOMMENDATIONS.
  CONTRACTOR TO REMOVE 1 REPLACE ALL EXISTING WINDOWS AND
  ASSOCIATED WATERFROOFING 1 FLASHING, U.N.O.
- CONTRACTOR TO REMOVE & REPLACE ALL EXISTING EXTERIOR DOORS AND ASSOCIATED WATERPROOFING & FLASHING, U.N.O.
- CONTRACTOR TO REMOVE EXISTING EXTERIOR FINISH MATERIAL, MATERPROOFING & FLASHING, U.N.O.
- CONTRACTOR TO REMOVE EXISTING ROOF MATERIAL, MATERPROOFING & FLASHING, U.N.O.

### ELEVATION KEYNOTES:

- ROOFING: MANUFACTURER: EAGLE ROOFING
  MATERIAL: CONCRETE
  STYLE: FLAT
  FROFILE: BEL AIR
  COLLECTION: 4505 BIERRA MADRE
  COLOR: CHARCOAL
  RISE RATING: CLASS A
  COMPLIANCE REPORT: UES ER 1900
- 2
- STUCCO: MANUFACTURER: SYSTEM: STICCO:

  MANUFACTURER:

  POSTEM:

  DIAMOND WALL THREE COAT

  W CRACK ISOLATION

  COLORTE:

  SMOOTH STEEL TROVELED

  AST ROUGH KHARL

  COMPLIANCE REPORT: ICC-ES-ESR 1194
- 3 STONE VENEER:
  MANUFACTURER:
  COLLECTION:
  PROFILE:
  COLOR:
  TYPE:
  COMPLIANCE REP ELDORADO STONE MODERN COASTAL REEF PEARL WHITE ADHERED STONE VE T: KC-ES-ESR-1215
- 4 GUTTERS & DOWNSPOUTS:
- 5 FRONT ENTRY GATE: MANUFACTURER: MATERIAL: FINISH: COLOR: CUSTOM BUILT WOOD STAINED TBD
- 6 GARAGE DOOR:
  MANUFACTURER:
  SERIES:
  MATERIAL:
  FINISH:
  COLOR:
  GLASS:
- 7 ENTRY DOOR:
  MANUFACTURER:
  MATERIAL:
  FINISH:
  COLOR:
- B EXTERIOR DOORS:
  MANUFACTURER:
  COLLECTION:
  MATERIAL:
  FINISH:
  EXTERIOR:
  COLOR:
  INTERIOR:
  COLOR:
- WAYNE DALTON GARAGE DOORS ALUMINUM & GLASS PAINTED BROWN TINTED

PAINTED TBD TBD TBD

KOLBE WINDOWS & DOORS VISTALUXE ALUMINUM CLAD WOOD

FOLDING DOORS:
MANUFACTURER:
TYPE:
MATERIAL:
FINISH:
COLOR:

MINDOMS

MANUFACTURER
COLLECTION:
STYLE:
MATERIAL:
FINISH:
EXTERIOR:
COLOR:
COLOR:

9

KOLBE WINDOWS & DOORS VISTALUXE FLUSH ALUMINUM CLAD WOOD PAINTED TBD TBD TBD

EAST & WEST EXTERIOR ELEV.

SHEET NUMBER:

A-5

RESIDENCI BILLSTEIN F 34821 DOHENY PLACE DANA POINT, CA

PROJECT NUMBER:

2018016

Studio

STUDIO 6 ARCHITECTS, INC ARCHITECTURE + PLANNING 2753 CAMINO CAPISTRANO, SUITE A-100 SAN CLEMENTE, CA 92672

BRIAN MUEHLBAUER PHONE: (949) 388-5300 FAX: (949) 388-3330 brian@studio6architects.com

BRIAN MUEHLBAUER

ROBERT WILLIAMS

PROJECT CONTACT:

PROJECT TEAM

BETH BILLSTEIN 34821 DOHENY PLACE DANA POINT, CA 92624

PROJECT MANAGER PHONE NUMBER: FAX NUMBER: EMAIL:


PRINCIPAL ARCHITECT.


DESIGN ARCHITECT


CLIENT:

MILESTONES / REVISIONS NO. DATE DESCRIPTION
4.5.19 DD MEETING
D5.19 CDP SUB. #2 ↑ 9.5.19 CDP SUB. #2
↑ 9.27.19 CDP SUB. #3

LICENSE STAMP

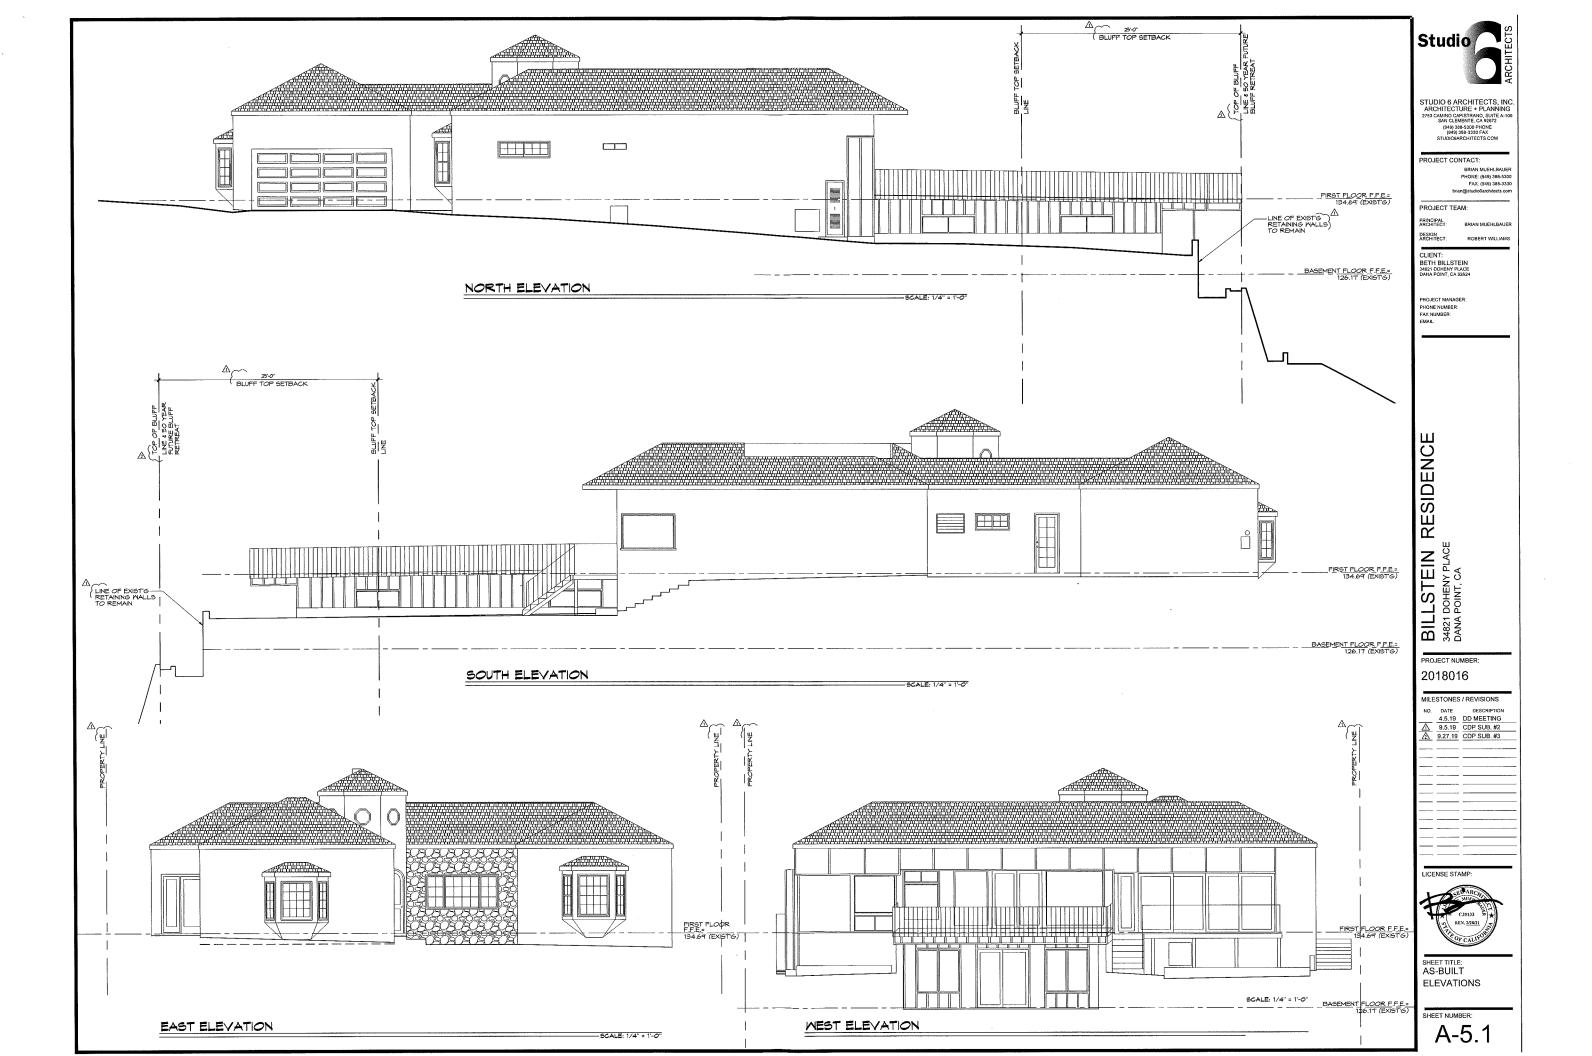

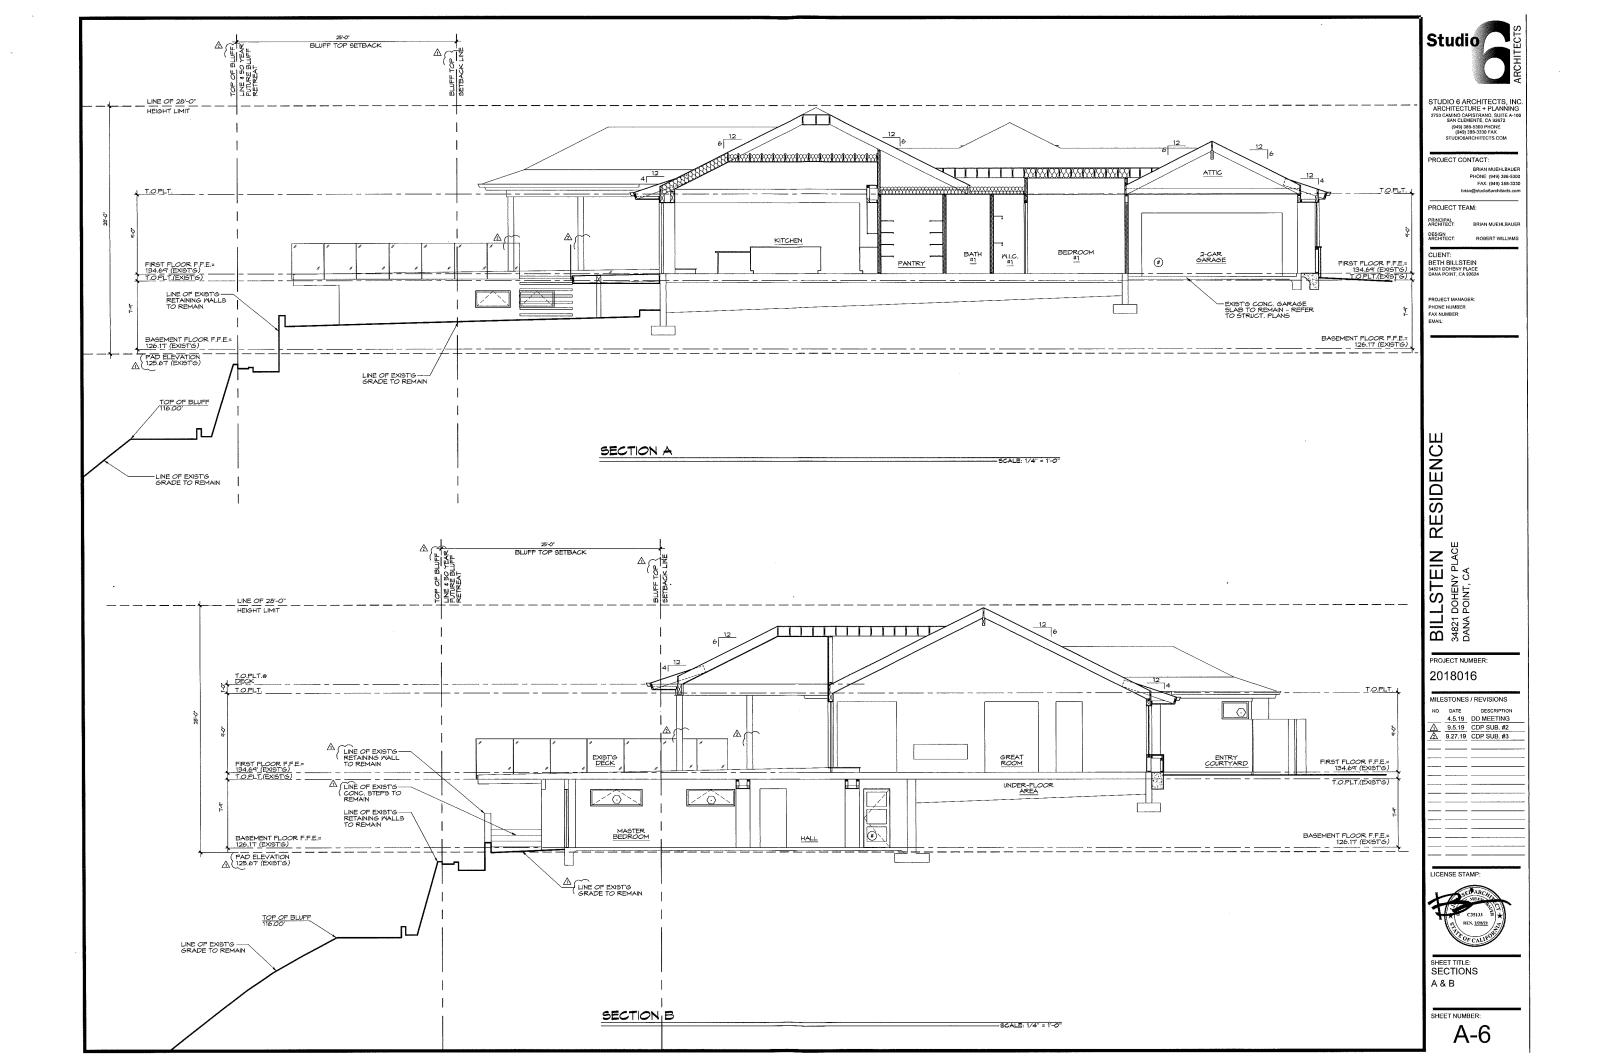

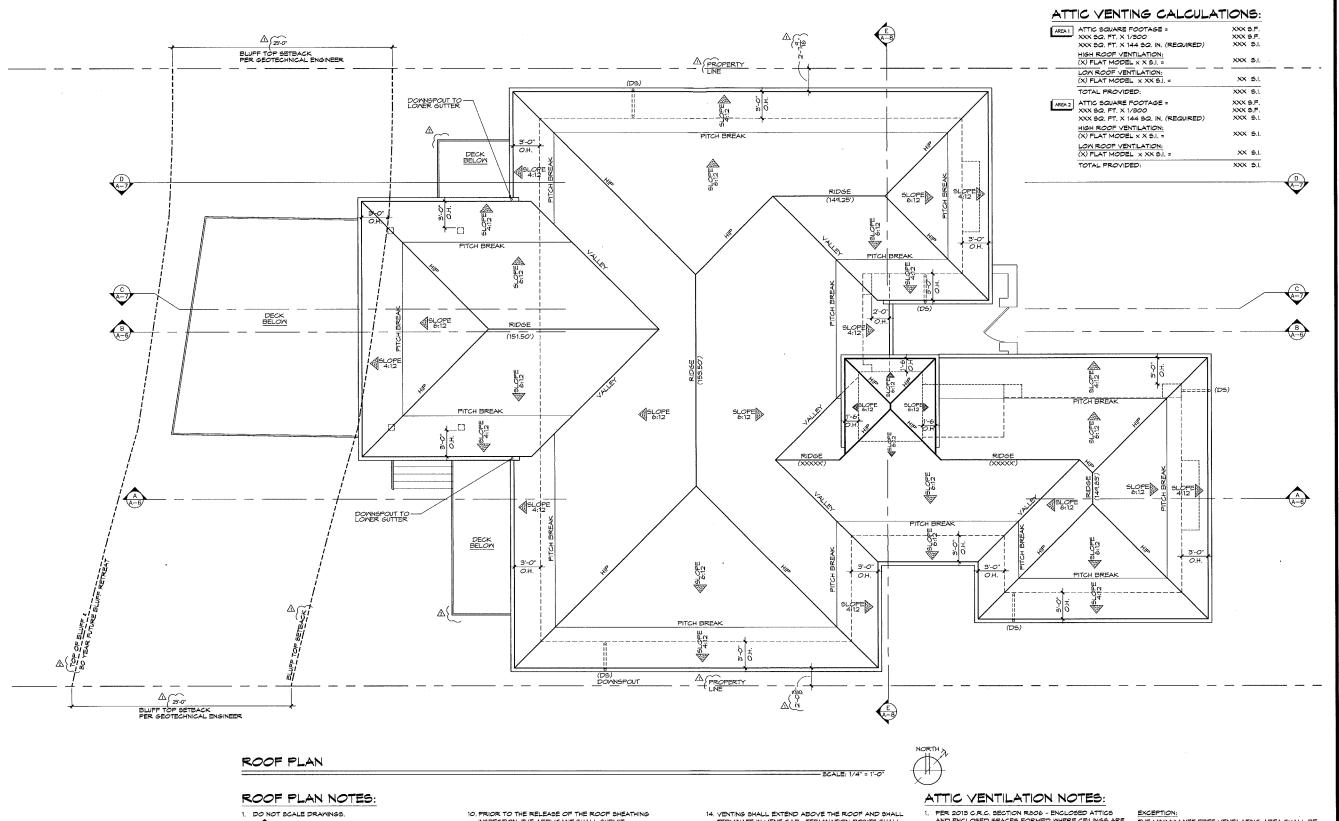

- 2. INDICATES ROOF PITCH AS NOTED ON THE
- ROOF PLAN.

  3. ALL PLUMBING AND EQUIPMENT VENTS MUST BE CONSOLIDATED AND LOCATED IN AREAS THAT MINIMIZE THEIR VISIBILITY. VENTS MUST BE AS LOW IN HEIGHT AS ALLONED BY CODE. ALL FLASHING, SHEET METAL, VENT STACKS AND PIPES
- SHALL BE COPPER.
  PROVIDE COPPER FLASHING AT ALL VALLEYS AND ROOF TO WALL CONDITIONS. REFER TO DETAILS.
- 6. IN "CALIFORNIA" DOUBLE FRAMING AREAS PROVIDE OPENINGS INTO MAIN ATTIC SPACE FOR ADEQUATE VENTILATION.

  IF "CALIFORNIA" DOUBLE FRAME AREA HAS MORE THAN
- 30" HEADROOM PROVIDE A 20" X 30" MIN. ACCESS THROUGH MAIN ROOF SHEATHING, VERIFY OPENINGS IN ROOF SHEATHING WITH STRUCTURAL ENGINEER.
- 2. ALL BOX COLUMNS AND "POP-OUTS SHALL REMAIN OPEN AT TOP PLATE LINE TO ALLON FOR VENTILATION.

  4. AT ALL AREAS WITHIN THE ROOF ATTIC WITH 50" MIN. CLEAR HEADROOM, PROVIDE A 20" X 50" MIN. ATTIC CLEAR HEADROOM, PROVIDE A 20" X 90" MIN, ATTIC ACCESS TO THOSE AREAS, ATTICS WITH APPLIANCES OR F.A.J. UNITS INSTALLED IN THEM, PROVIDE A 30" X30" MIN, ATTIC ACCESS, (PROVIDED F.A.J., MAY PASS THROUGH) WITH 90" MIN, CLEAR HEADROOM, PROVIDE WEATHER STRIPS AT PANEL TO PREVENT BACK DRAFT.
- INSPECTION, THE APPLICANT SHALL SUBMIT CERTIFICATION, BY A SURVEY OR OTHER APPROPRIATE METHOD, THAT THE HEIGHT OF THE STRUCTURES IS IN METHOD, THAT THE HEIGHT OF THE STRUCTURES IS IN COMPLIANCE WITH THE ADOPTED APPROVAL RESOLUTION, AND THE HEIGHT LIMITATIONS (IF ANY) OF THE APPLICABLE ZONING DISTRICT.
- ALL ROOF EAVE GUTTERS SHALL BE 5" SQUARE, NON-EXTRUDED, CONTINUOUS COPPER NITH NO SEAMS, ALL DOWNSPOUTS SHALL BE COPPER, 5" DIA. ROUND NITH MELDED SEAMS, REFER TO ROOF PLAN AND EXTERIOR ELEVATIONS FOR LOCATIONS.
- 12. COORDINATE CONNECTION OF CONTINUOUS ROOF EAVE GUITERS AND DOWNSPOUTS TO ALLOW WATER TO FLOW AWAY FROM THE STRUCTURE. DOWNSPOUTS SHOULD BE CONNECTED TO CLOSED PIPES THAT DISCHARGE INTO SITE STORM DRAIN SYSTEM OR ONTO PAVED SURFACES THAT CARRY THE WATER AWAY AT LEAST 5'-0" FROM THE BUILDINGS FOUNDATION.
- 13. ANY FORCED AIR UNITS LOCATED IN THE ATTIC MUST BE . ANY FORCED AIR UNITS LOCATED IN THE ATTIC MUST BE POSITIONED IN SUCH A MANNER THAT THE REQUIRED DISTANCE FROM THE VENT OUTLET TO THE TOP OF THE FLUE CAP IS MITHIN THE ATTIC, ALLOWING THE EXTERIOR HEIGHT OF THE FILLS CAP ABOVE THE FINISHED ROOFING TO BE THE MINIMUM ALLOWED BY CODE.
- 14. VENTING SHALL EXTEND ABOVE THE ROOF AND SHALL TERMINATE IN VENT CAP. TERMINATION POINTS SHALL BE AT LEAST 4 FEET BELOW OR HORIZONTALLY FROM BE AT LEAST 4 FEET BELOW OR HORIZONTALLY FROM AND 1 FOOT ABOVE ANY OPENING INTO THE BUILDING, BE AT LEAST 3 FEET ABOVE ANY FORCED AIR INLET INTO THE BUILDING LOCATED WITHIN 10 FEET, AND SHALL BE 4 FEET AWAY FROM THE PROPERTY LINE, PER 2016 C.M.C. AND 2016 C.P.C.
- 15. ROOF ELEVATIONS ARE TO TOP OF FINISHED MATERIAL.
- 16. DS DENOTES DOWNSPOUT LOCATION

#### ROOFING SPECIFICATIONS:

EAGLE ROOFING CONCRETE FLAT BEL AIR 4503 SIERRA MADRE MANUFACTURER: MATERIAL: MALEGALIST STATE S

 PER 2013 C.R.C. SECTION R806 - ENCLOSED ATTICS AND ENCLOSED SPACES FORMED WHERE CEILINGS ARE APPLIED DIRECTLY TO THE UNDERSIDE OF ROOF RAFTERS SHALL HAVE A CROSS VENTILATION FOR EACH SEPARATE SPACE BY VENTILATING OPENINGS PROTECTED AGAINST THE ENTRANCE OF RAIN OR PROTECTED AGAINST THE ENTRANCE OF RAIN OR SNOW, VENTILATION OPENINGS SHALL HAVE A LEAST DIMENSION OF 1/6, INCH MINIMUM AND 1/4, INCH MAXIMUM, VENTILATION OPENINGS HAVING A LEAST DIMENSION LARGER THAN ½ INCH SHALL BE PROVIDED WITH CORROSION-RESISTANT WIRE CLOTH SCREENING CORROSION-RESISTANT WIRE CLOTH SCREENING HARDWARE CLOTH OR SIMILAR MATERIAL WITH OPENINGS HAVING A LEAST DIMENSION OF 1/16" MINIMUM AND 1/4" MAXIMUM. OPENINGS IN ROOF FRAMING MEMBERS SHALL CONFORM TO THE REQUIREMENTS OF SECTION RSO2.1.

MINIMUM VENT AREA THE MINIMUM NET FREE VENTILATING AREA SHALL BE 1/50 OF THE AREA OF VENTED SPACE.

THE MINIMUM NET FREE VENTILATING AREA SHALL BE THE MINIMUM NET FREE VENTILATING AREA BHALL BE 1/500 OF THE AREA OF VENTED SPACE PROVIDE ONE OR MORE OF THE FOLLOWING CONDITIONS ARE MET:

1. IN CLIMATE ZONES 14 & 16, A CLASS | OR || VAPOR RETARDER || IS INSTALLED ON THE WARM-IN-NINTER SIDE OF THE CEILING.

2. AT LEAST 40% AND NOT MORE THAN 50% OF THE REQUIRED VENTILATING AREA IS PROVIDED THE REQUIRED VENTILATING AREA IS PROVIDED.

BY VENTILATORS LOCATED IN THE PPER PORTION OF THE ATTIC OR RAFTER SPACE. UPPER VENTILATORS SHALL BE LOCATED NO MORE THAN 3 FEET BELOW THE RIDGE OR HIGHEST POINT OF THE SPACE, MEASURED VERTICALLY, WITH THE BALANCE OF THE VERTICALLY, MITH THE BALANCE OF THE REQUIRED VERTILATION PROVIDED BY EAVE OR CORNICE VENTS, MHERE THE LOCATION OF WALL OR ROOF FRAMIG MEMBERS CONFLICTS WITH THE INSTALLATION OF UPPER VENTILATORS, INSTALLATION MORE THAN 3 PEET BELOW THE RIDGE OR HIGHEST POINT OF THE SPACE SHALL RESIDENCE.

# **Studio**

ROJECT CONTACT:

BRIAN MUEHLBAUEF PHONE: (949) 388-5301 FAX: (949) 388-3331

PROJECT TEAM

PRINCIPAL ARCHITECT

DESIGN ARCHITECT ROBERT WILLIAM

CLIENT: BETH BILLSTEIN 34821 DOHENY PLACE DANA POINT, CA 92624

PROJECT MANAGI PHONE NUMBER: FAX NUMBER:

RESIDENC

BILLSTEIN F 34821 DOHENY PLACE DANA POINT, CA

PROJECT NUMBER

2018016

MILESTONES / REVISIONS 4.5.19 DD MEETING ↑ 9.5.19 CDP SUB. #2 ↑ 9.27.19 CDP SUB. #3


LICENSE STAMF



**NEW ROOF** PLAN

SHEET NUMBER:

A-9

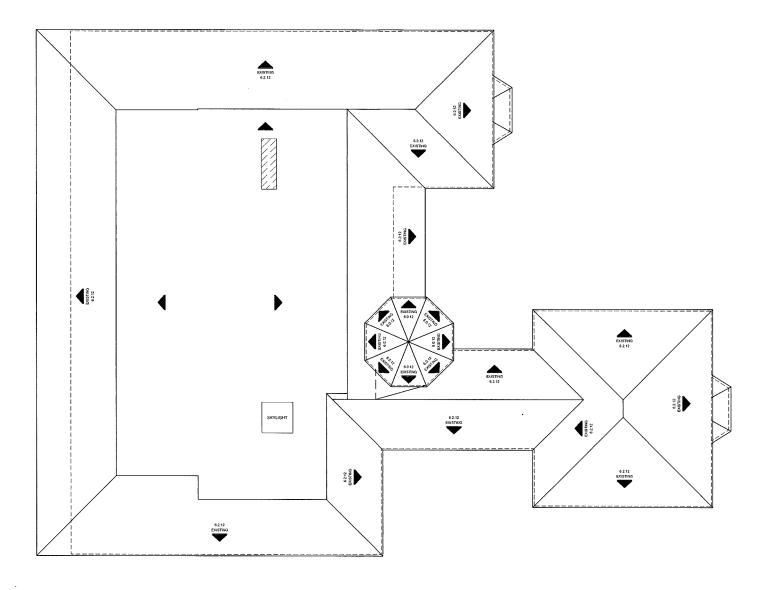

### AS-BUILT / DEMO ROOF PLAN



ROOF DEMOLITION NOTES:

1. DO NOT SCALE DRAWINGS.

2. ALL ROOFINS, FLASHING, UNDERLAYMENT, SKYLIGHTS, JACKS, PLYWOOD SHEATHG, FRAMING, ETC. TO BE REMOVED. PLACE AS DENOTED IN THESE DOCUMENTS.



STUDIO 6 ARCHITECTS, INC. ARCHITECTURE + PLANNING 2753 CAMINO CAPISTRANO, SUITE A-100 SAN CLEMENTE, CA 92672 (949) 288-5300 PHONE (949) 398-3300 FAX STUDIOSARCHITECTS.COM

PROJECT CONTACT:

BRIAN MUEHLBAUER
PHONE: (949) 388-5300
FAX: (949) 388-3330
brian@studio6architects.com

PROJECT TEAM:

PRINCIPAL ARCHITECT: BRIAN MUEHLBAUEF DESIGN ARCHITECT: ROBERT WILLIAMS

CLIENT: BETH BILLSTEIN 34821 DOHENY PLACE DANA POINT, CA 92624

PROJECT MANAGER PHONE NUMBER: FAX NUMBER: EMAIL:

BILLSTEIN RESIDENCE 34821 DOHENY PLACE DANA POINT, CA

PROJECT NUMBER:

2018016

MILESTONES / REVISIONS

NO. DATE DESCRIPTION
4.5.19 DD MEETING
9.5.19 CDP SUB. #2
9.27.19 CDP SUB. #3



SHEET TITLE: AB / DEMO ROOF PLAN

SHEET NUMBER:

A-9.1



Front (East) Elevation



PRINCIPAL ARCHITECT: DESIGN ARCHITECT:

BILLSTEIN RESIDENCE 34821 DOHENY PLACE DANA POINT, CA

PROJECT NUMBER: 2018016

MILESTONES / REVISIONS

NO. DATE DESCRIPTION

4.5.19 DD MEETING



SHEET TITLE: NEW EXTERIOR ELEVATIONS

SHEET NUMBER:
A-10