







PRICE
RESIDENCE

48 Monarch Bay Dr. Dana Point, CA 92629


CRUPI CONSTRUCTION INC.

construction - design - management
32221 Azores Rd., Dana Point, CA 92629
949-309-6691

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issued for	rev	date

seals and signatures

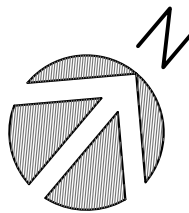

drawing title


SITE PLAN

scale 1/8"=1'-0"

date 10/23/2017

drawing number

A-1

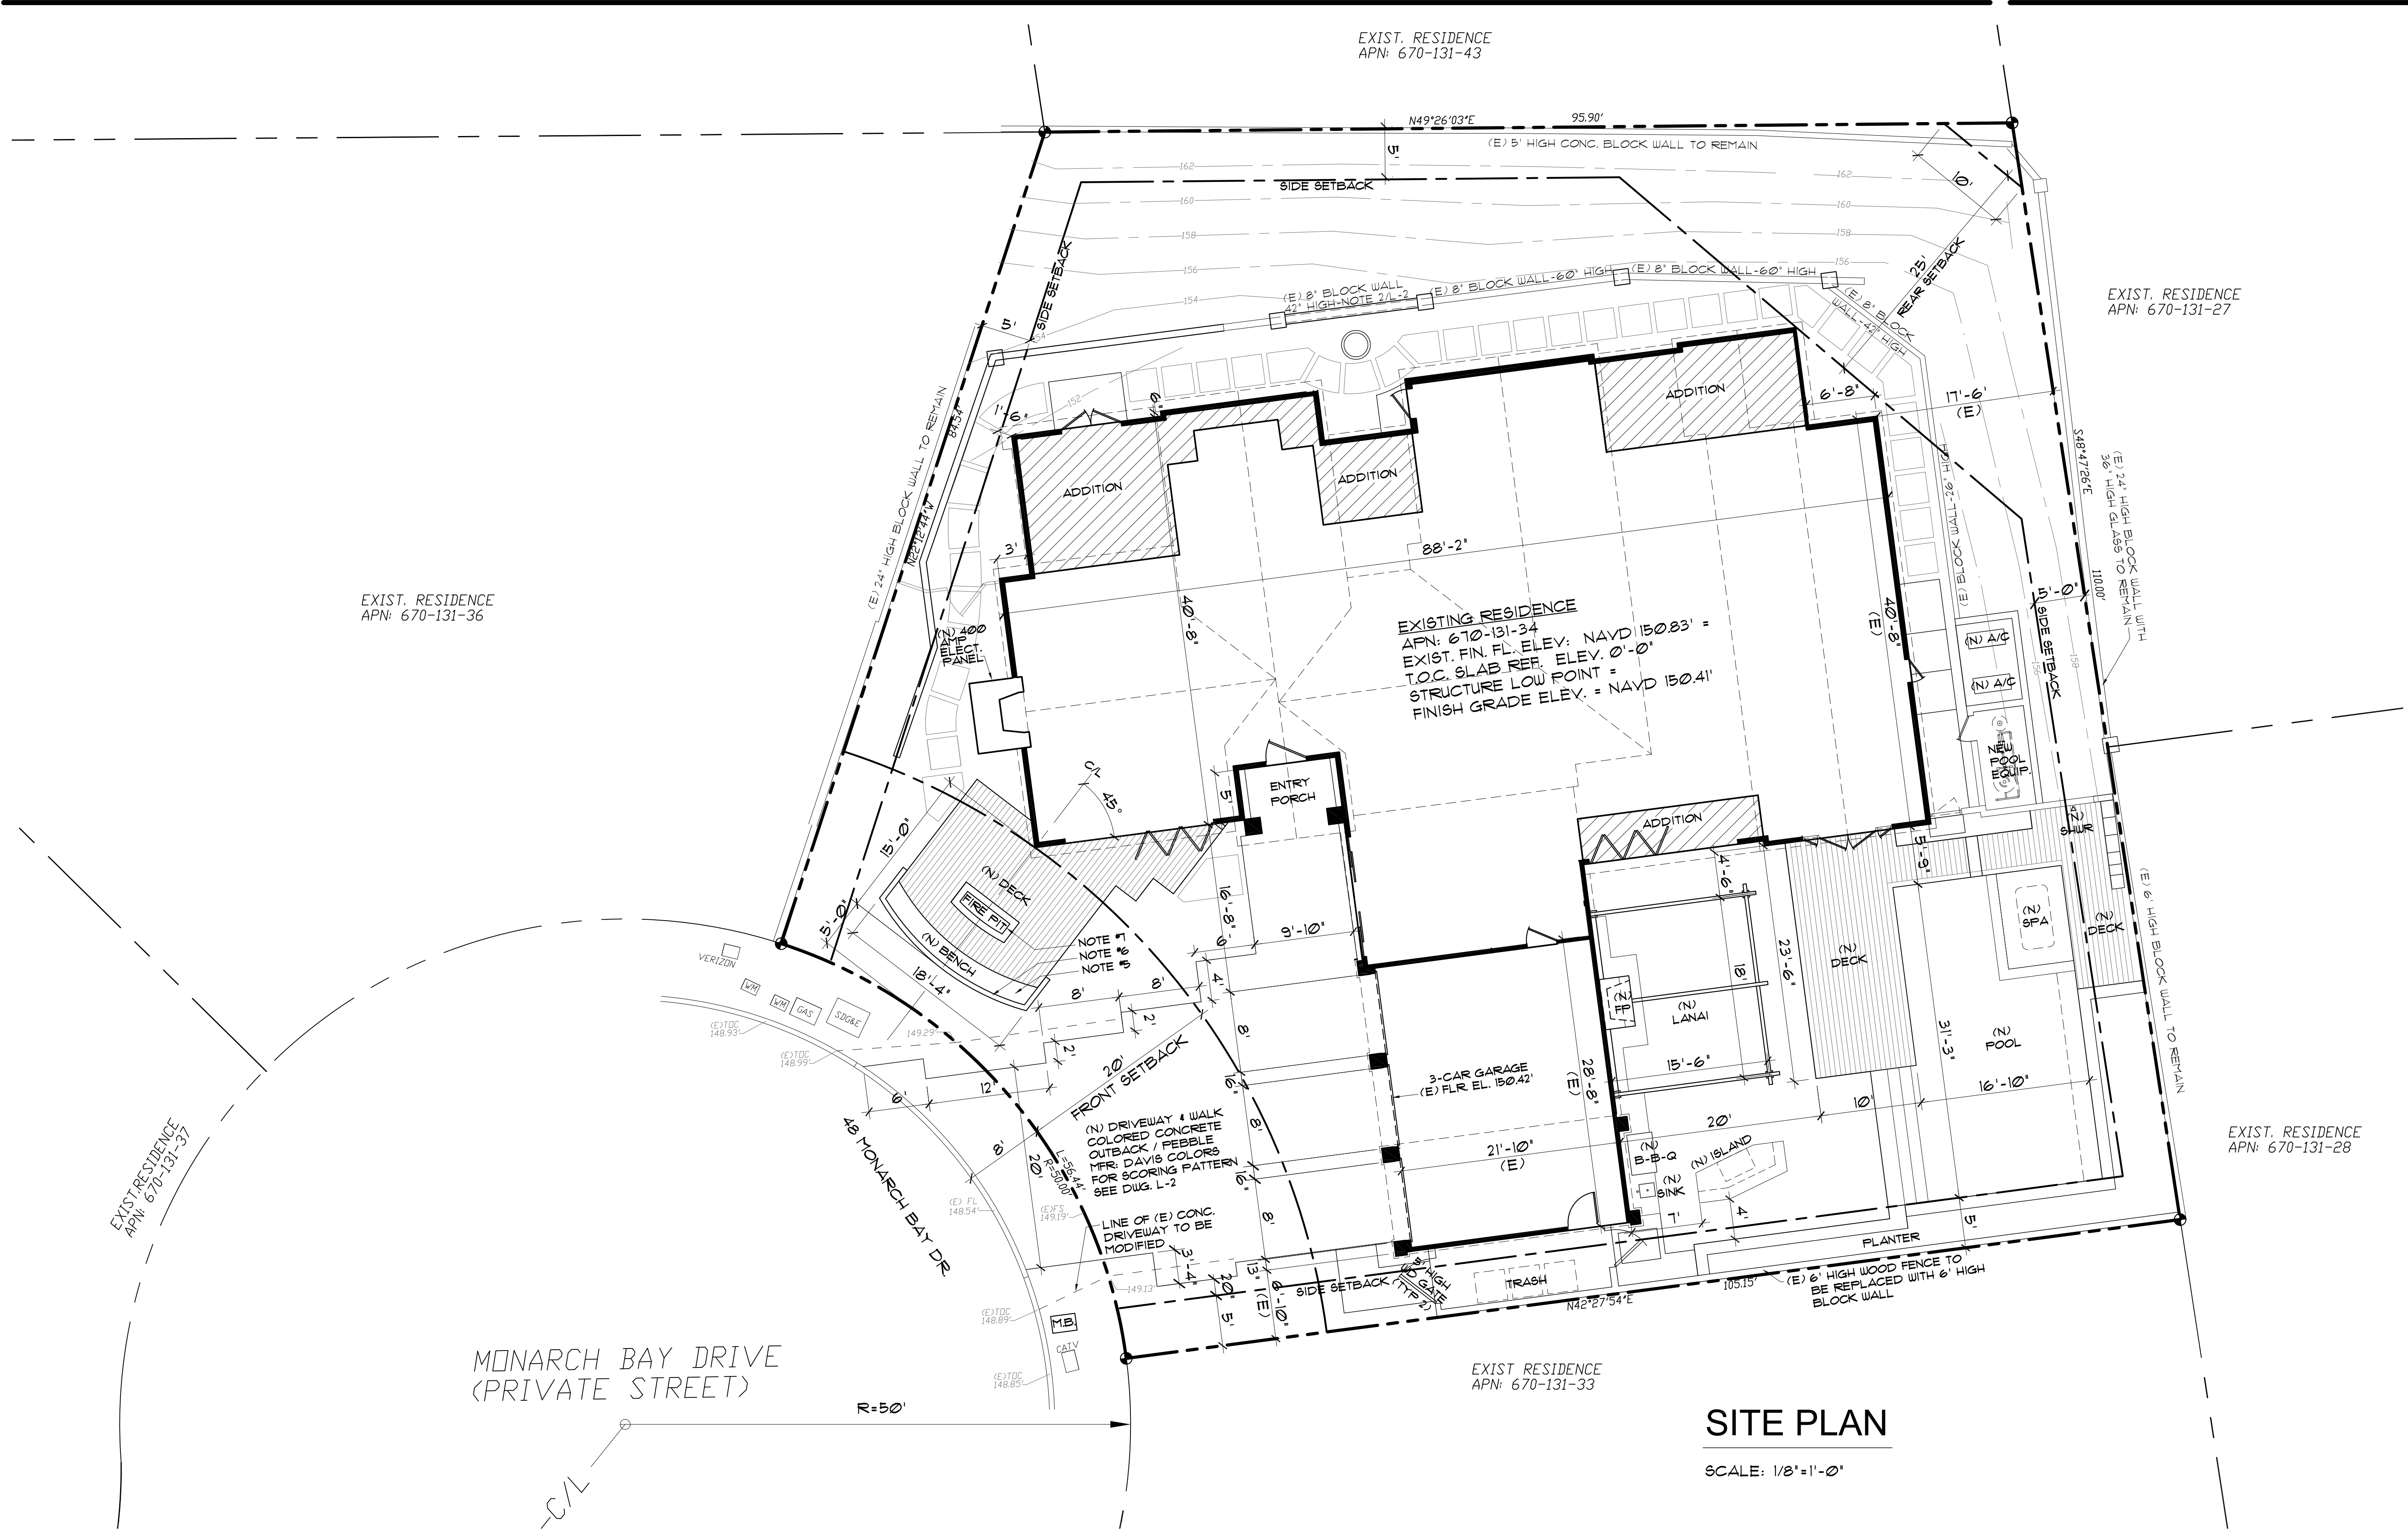


SITE PLAN

SCALE: 1/8"=1'-0"

NOTES

- SEE LANDSCAPE SHEETS L-2 AND L-3 FOR HARDSCAPE CONSTRUCTION DETAILS AND MATERIALS.
- (N) 16" HIGH CONCRETE SEAT.
- (N) 28" HIGH CONCRETE BACKREST WALL.
- (N) 16" HIGH CONCRETE FIREPIT.
- CONNECT NEW DRAINS TO EXISTING DRAINAGE SYSTEM.
- DRAINAGE AREA SHALL BE GRADED TO DRAIN SURFACE WATER AWAY FROM FOUNDATION WALLS. THE GRADE SHALL FALL A MINIMUM OF 6" INCH WITHIN THE FIRST 10 FEET.
- THE DISCHARGE OF POLLUTANTS TO ANY STORM DRAINAGE SYSTEM IS PROHIBITED. NO SOLID WASTE, PETROLEUM BYPRODUCTS, SOIL PARTICULATE, CONSTRUCTION WASTE MATERIALS, OR WASTEWATER GENERATED ON CONSTRUCTION SITES OR BY CONSTRUCTION ACTIVITIES SHALL BE PLACED, CONVEYED OR DISCHARGED INTO THE STREET, GUTTER OR STORM DRAIN SYSTEM.

VICINITY MAP

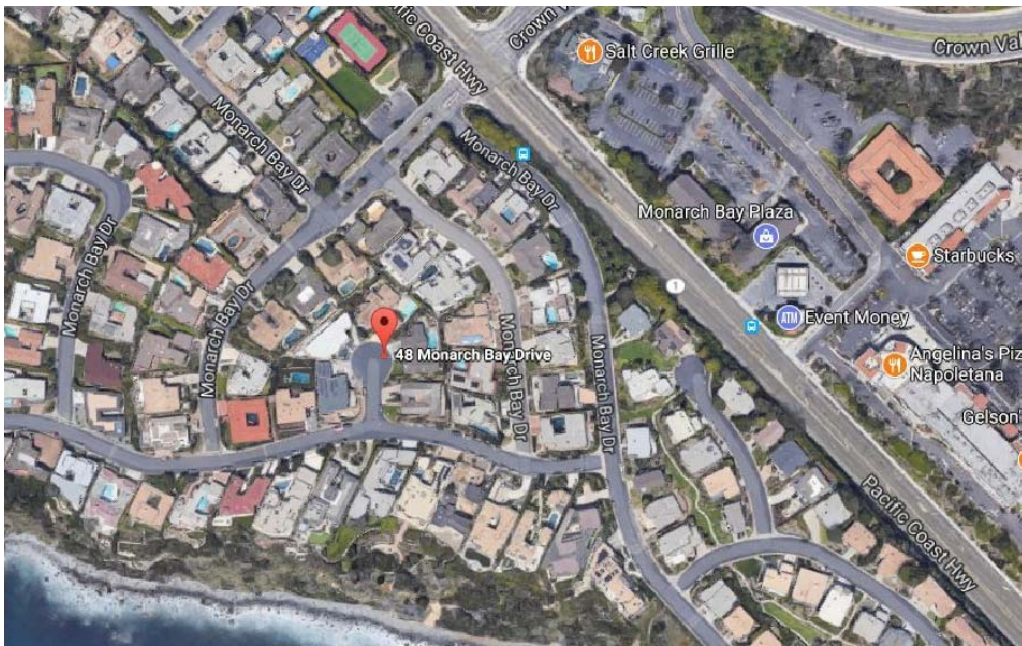

SITE INFORMATION

BUILDING AREA:
- HABITABLE (EXIST) 3,243 S.F.
- HABITABLE ADDITION 888 S.F.
- NEW HABITABLE TOTAL 4,131 S.F.
- NEW ENTRY PORCH 63 S.F.

SITE INFORMATION:
ZONING : RSF 4
LOT AREA : 11,500 S.F.

LEGAL DESCRIPTION:
TRACK 3039 LOT 36
ASSESSOR PARCEL NO. : 670-131-34
PROJECT ADDRESS:
48 MONARCH BAY DR. DANA POINT, CA 92629

LEGEND

- CONTOUR LINES (9-FOOT CONTOUR INTERVAL)
- SETBACK LINE
- PROPERTY LINE
- ROOFLINE PROJECTION

GENERAL NOTES:

- KEY NOTES – □
1. DIRECT VENT FIREPLACE EXIT THRU SIDE WALL AND ROOF. MFR. BY MAJESTIC MODEL: TBD

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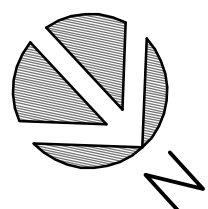
(RVP) (CONSTRUCTION) INC.

Construction - design - management
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949-309-6691

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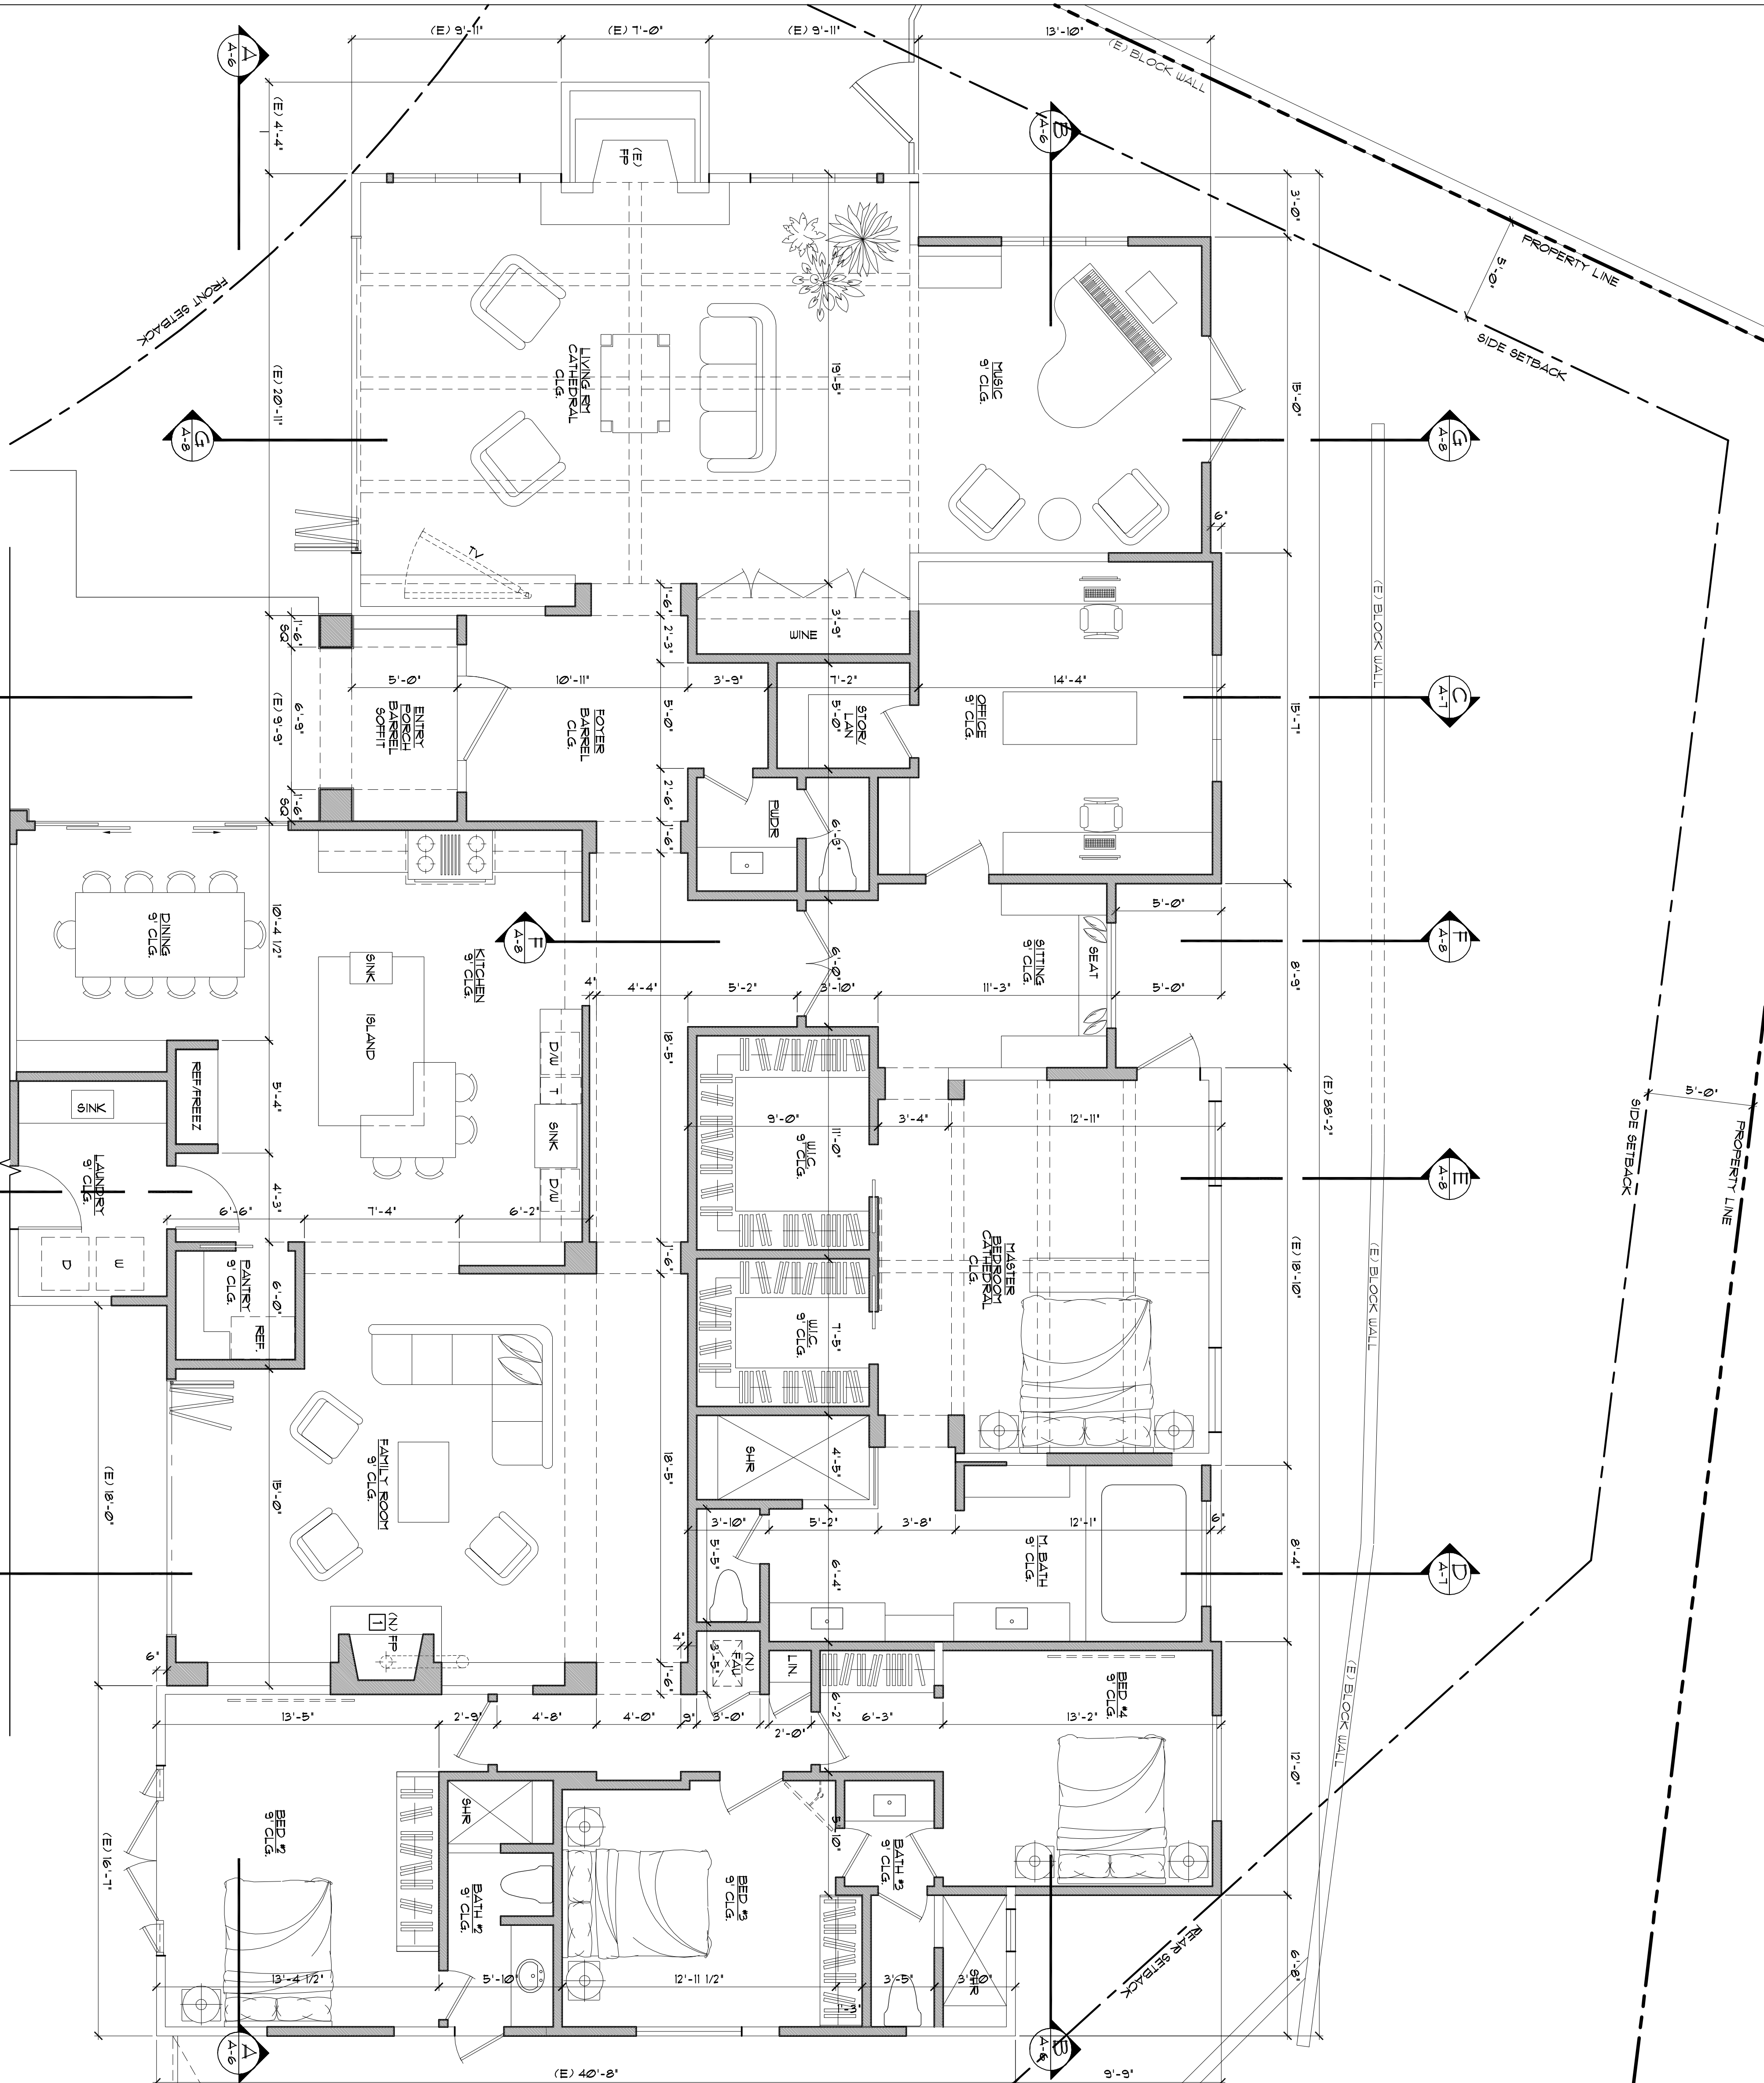
Drawing title

FLOOR PLAN
PART-1

Scale
1/4"=1'-0"
Date
10/23/2017
Drawing Number
A-2

FLOOR PLAN SYMBOLS

- OVERHEAD BEAM OR CABINET
- (E) WALL TO REMAIN
- (N) WALL
- LETTER INDICATES BLDG SECTION
- DIRECTION OF SECTION CUT
- SHEET NUMBER WHERE SECTION IS DRAIN



FLOOR PLAN-PART 1

SCALE: 1/4"=1'-0"

GENERAL NOTES:

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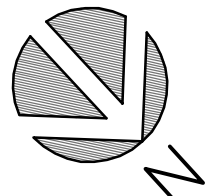
(R)VPi (ON)STRUCTION INC.

construction - design - management
32221 Azores Rd., Dana Point, CA 92629
949-309-6651

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Drawing title


ROOF PLAN AND
FLOOR PLAN- PART 2

Scale: 1/4"=1'-0"

Date: 10/23/2017


Drawing number

A-3

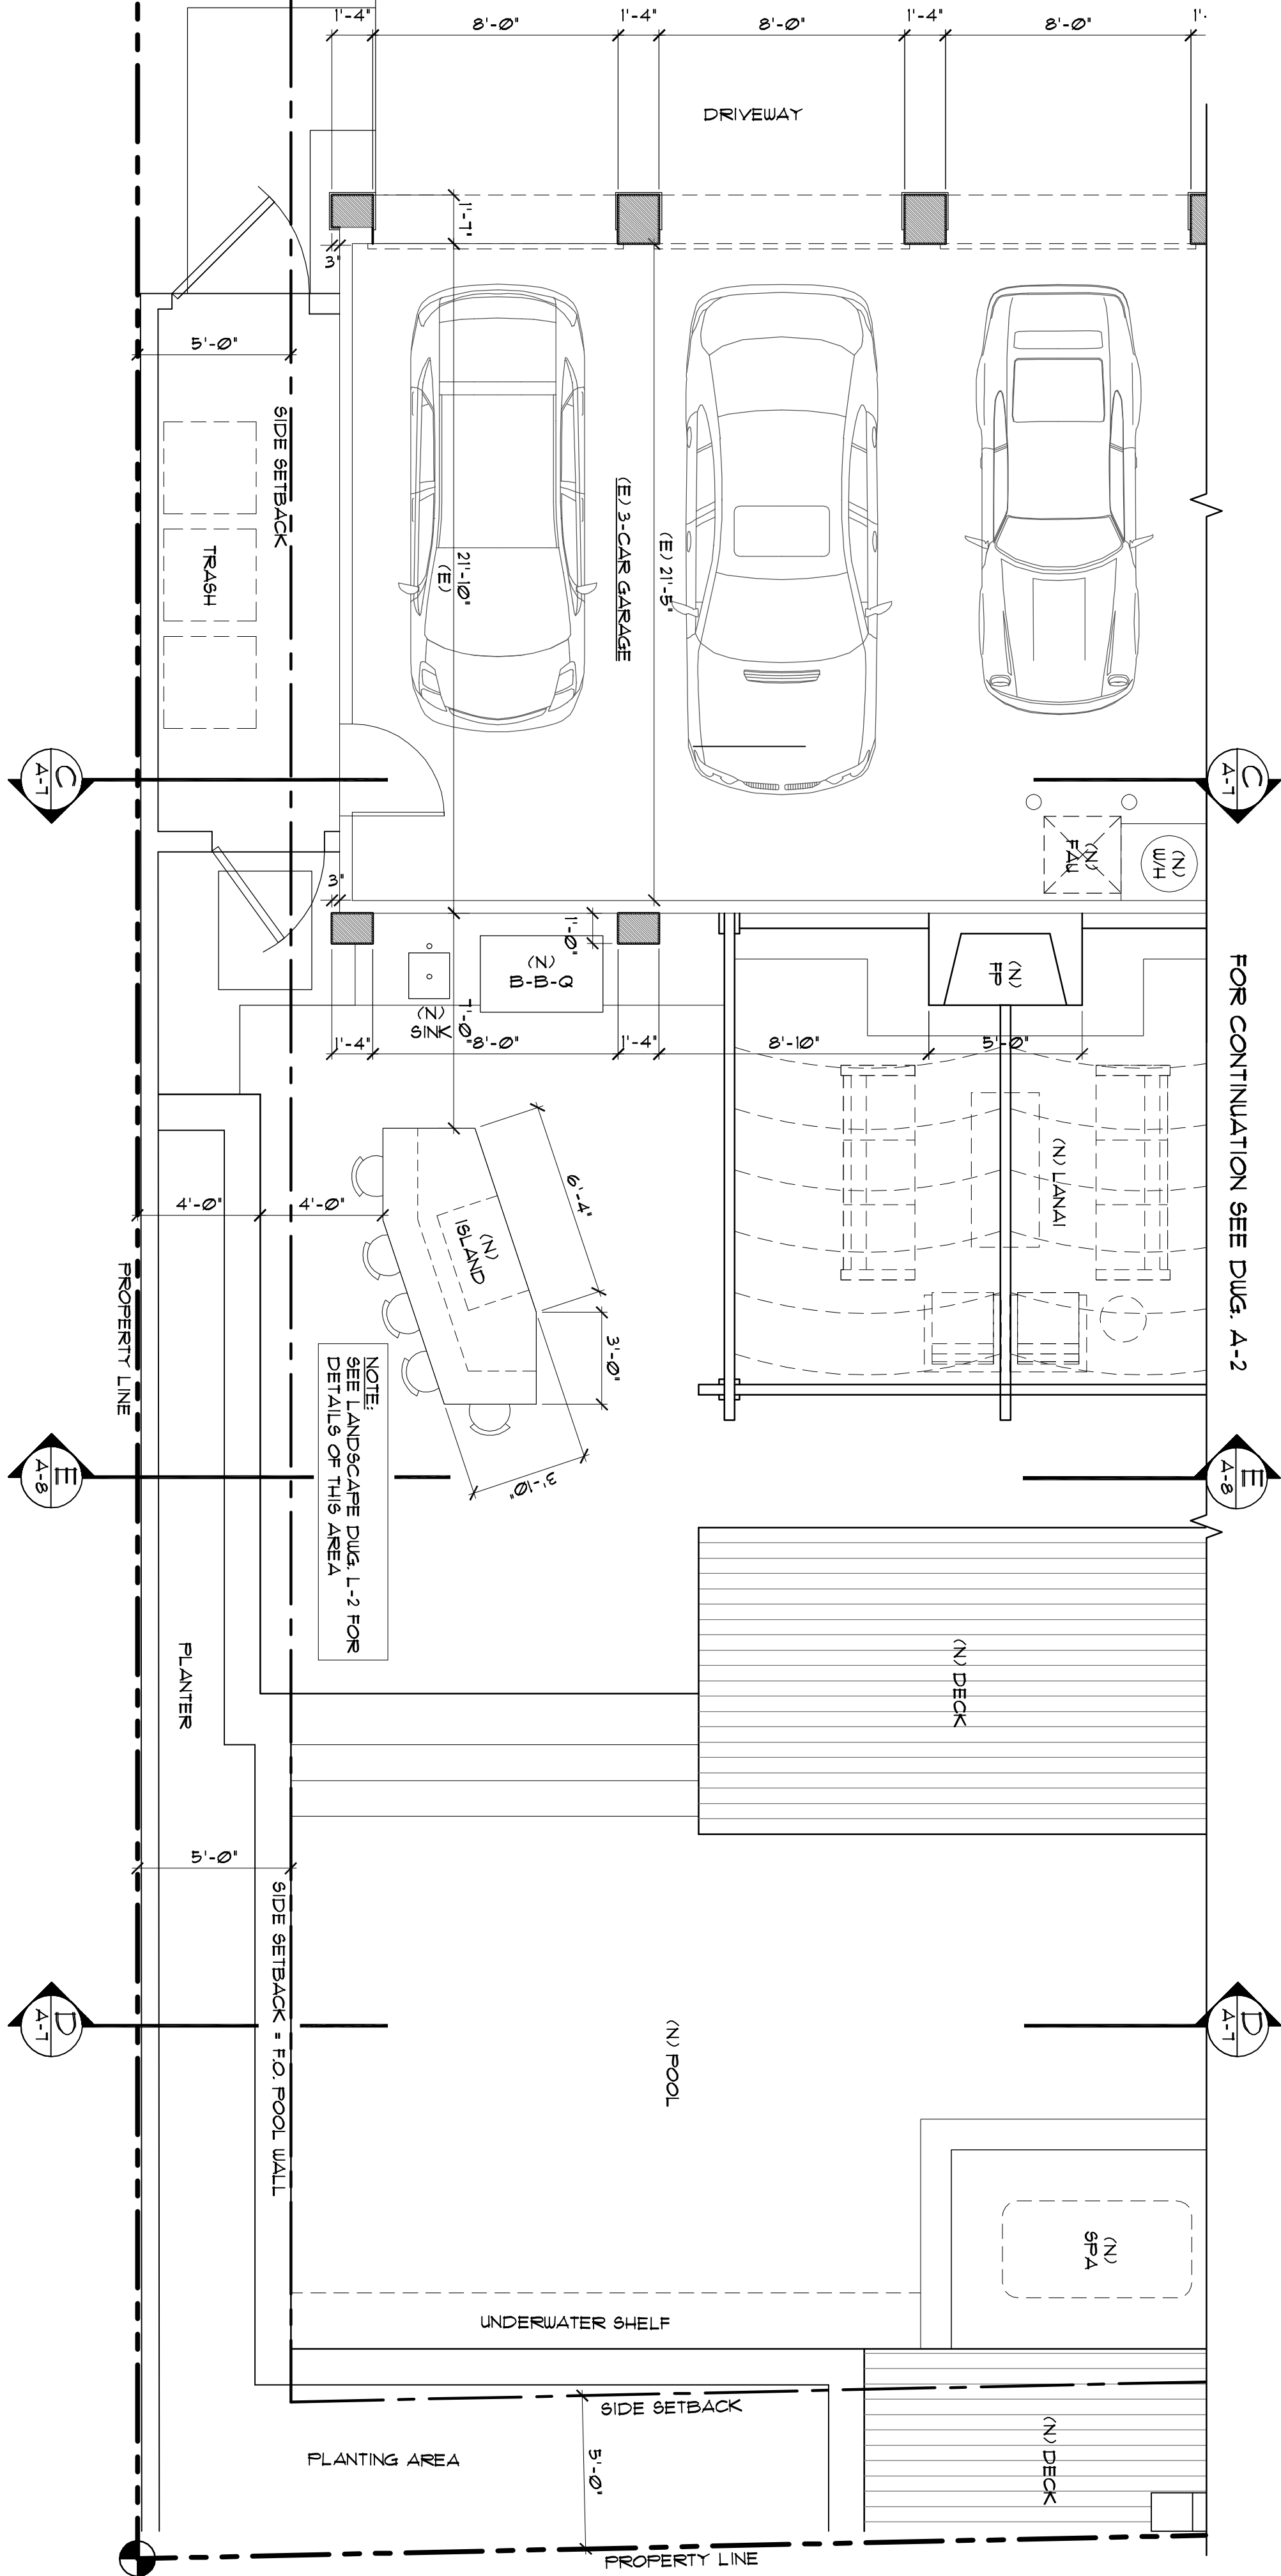

FLOOR PLAN-PART 2

Scale: 1/4"=1'-0"

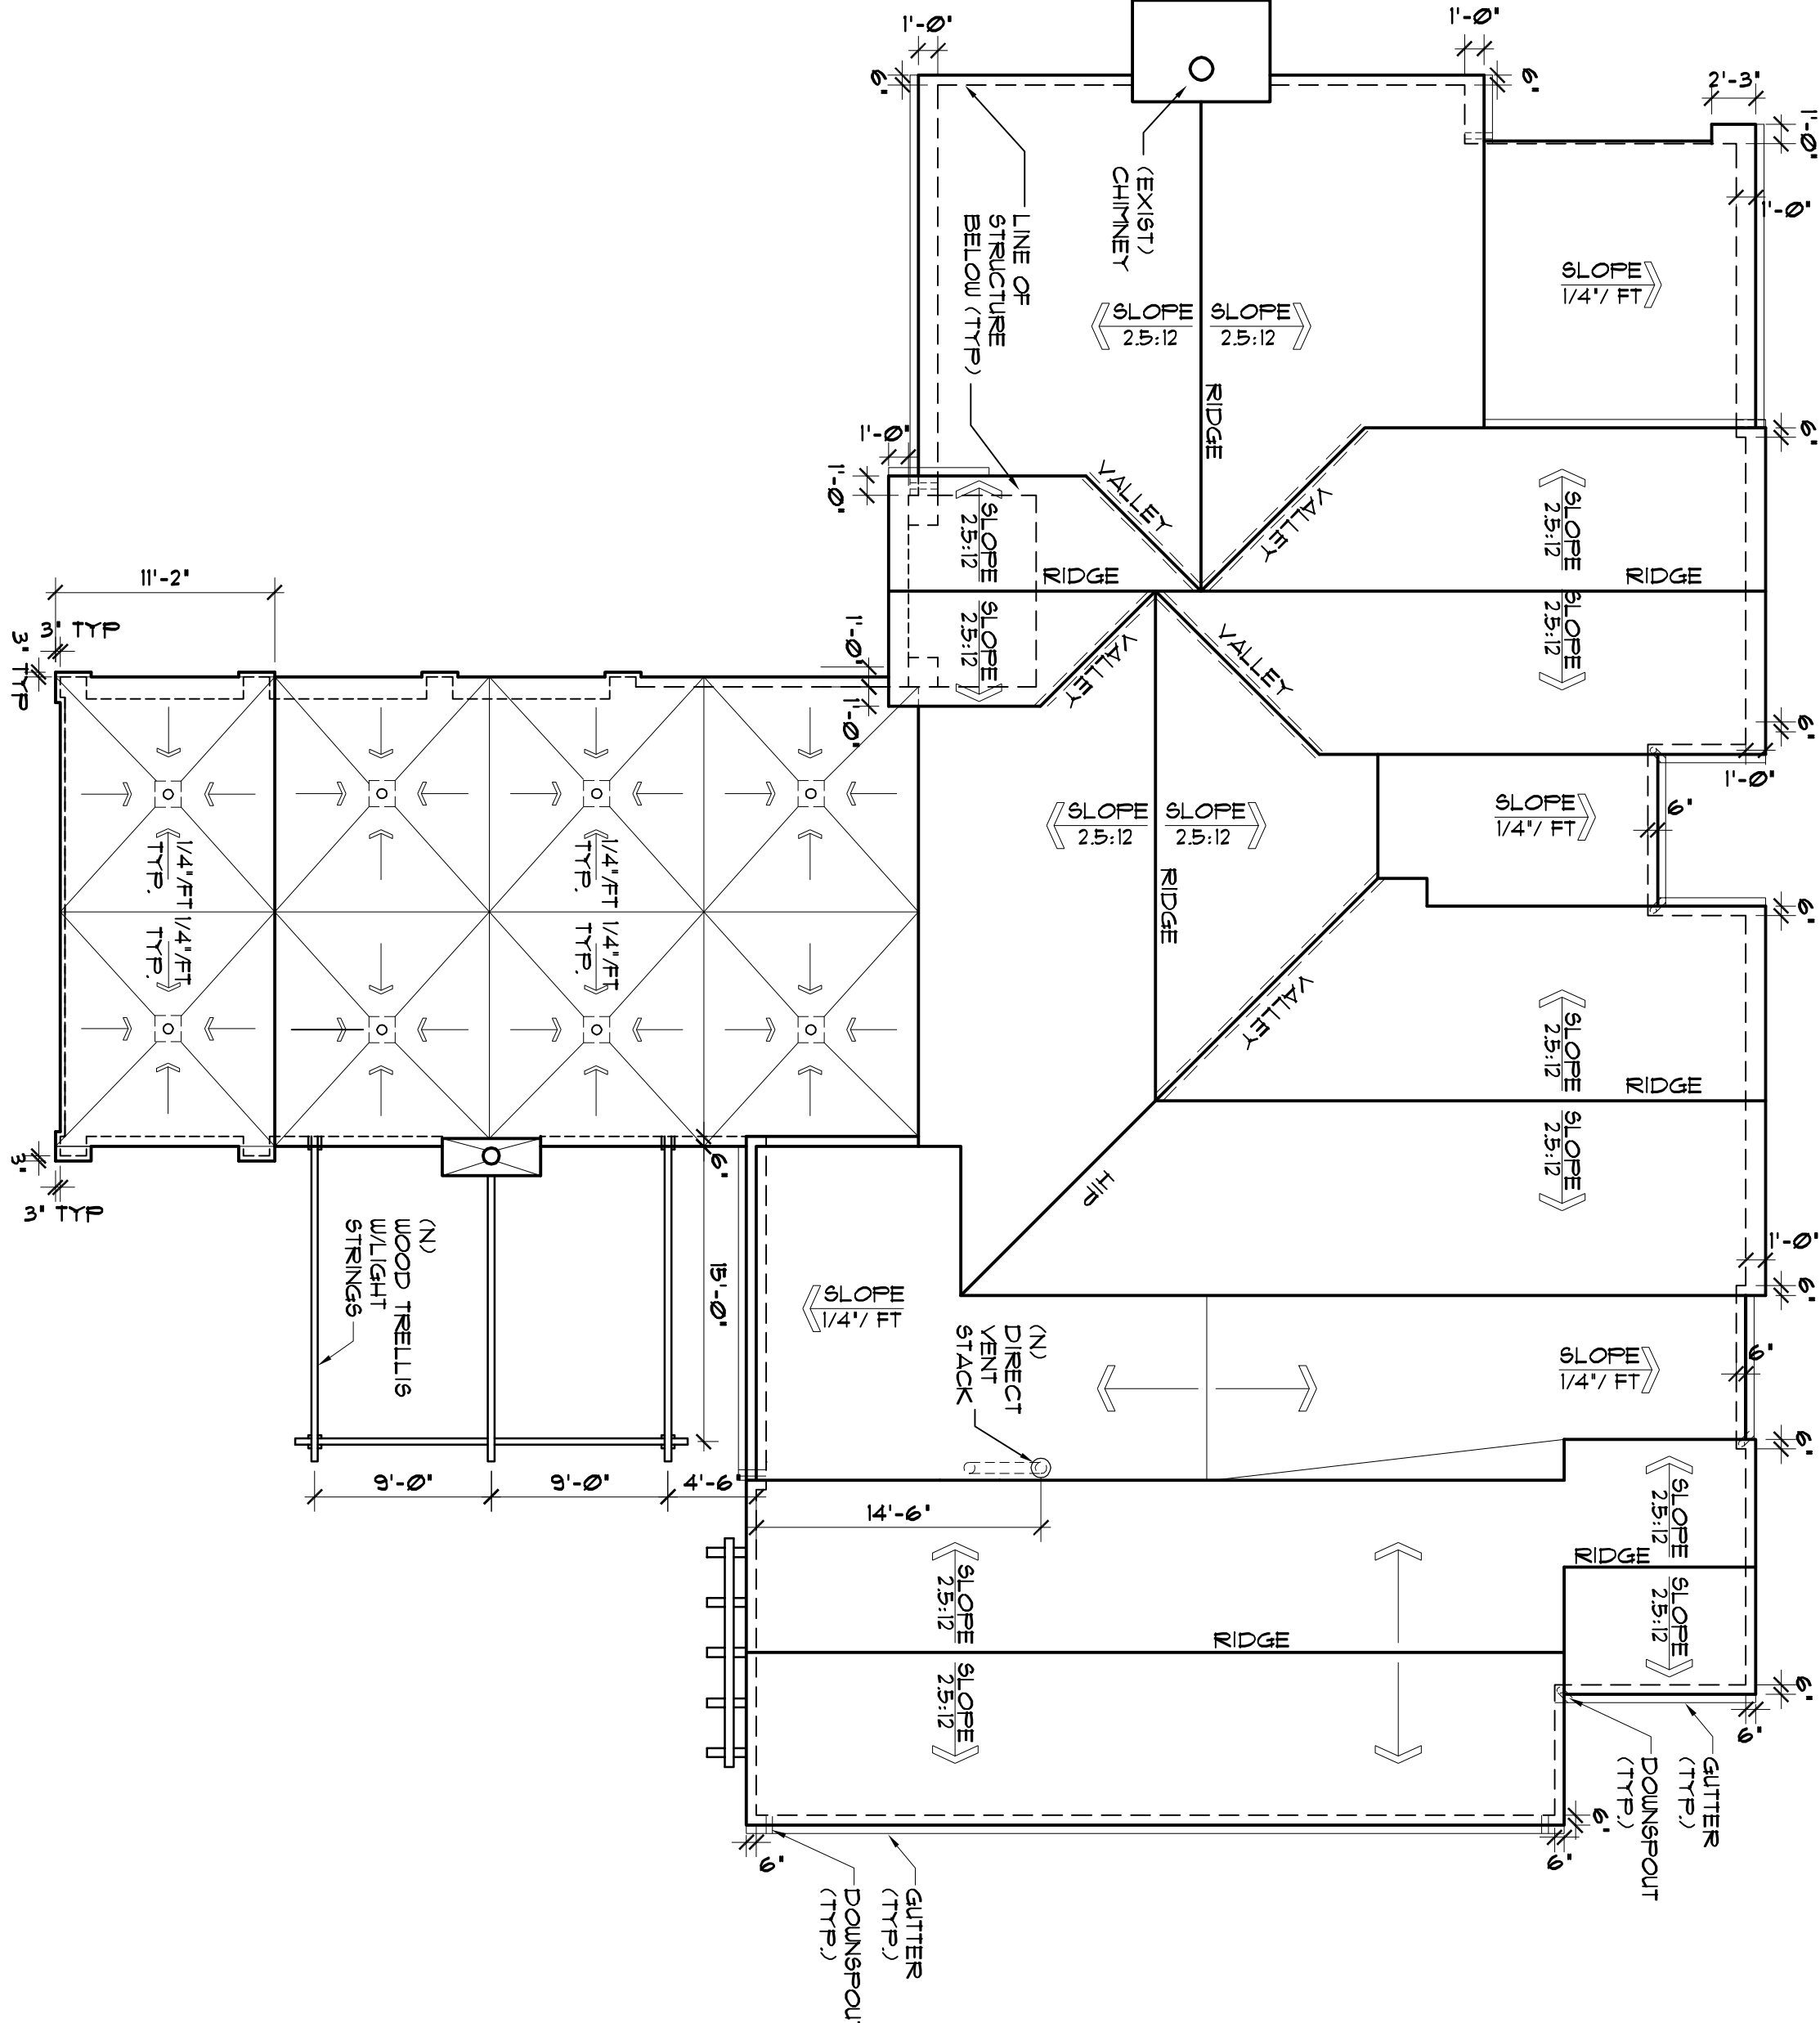

ROOF PLAN

Scale: 1/8"=1'-0"

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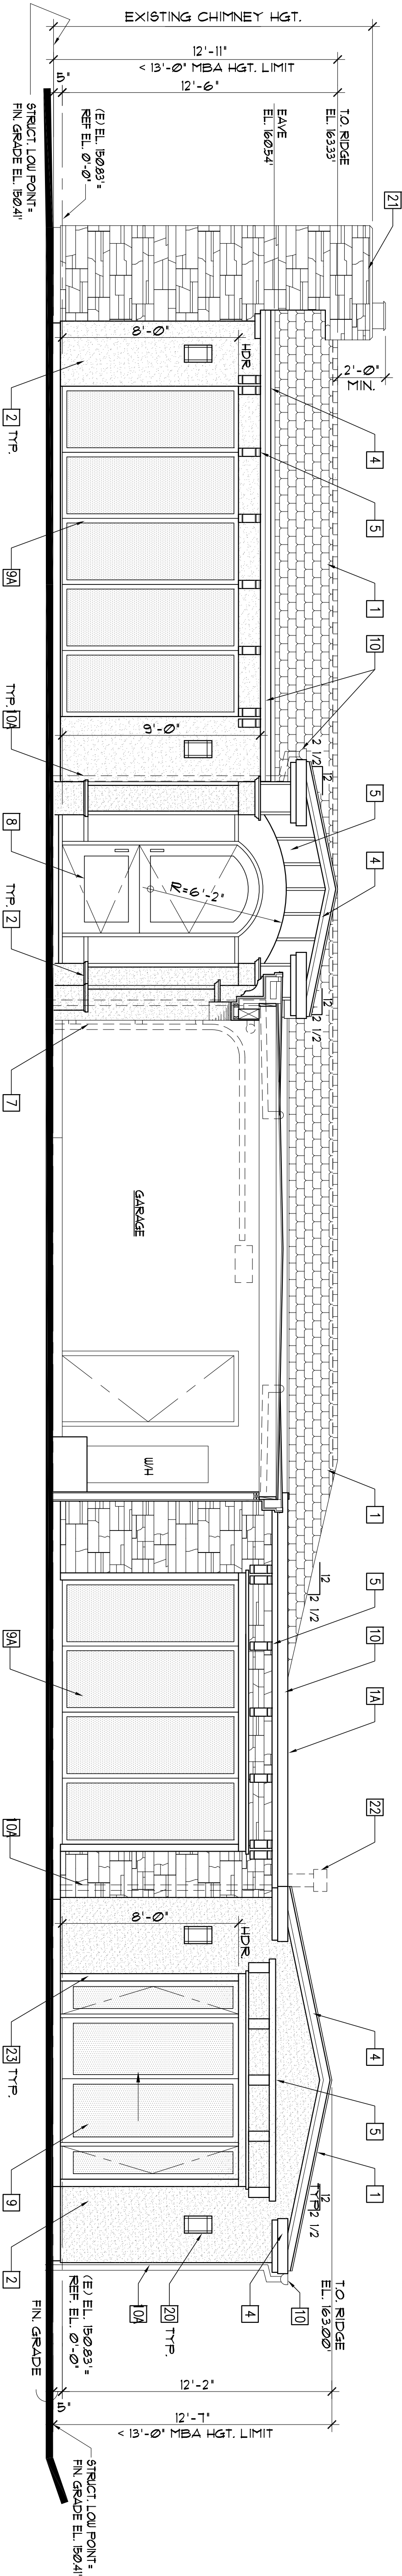
seals and signatures

drawing title

EXTERIOR ELEVATIONS


AS NOTED	AS NOTED
date	10/23/2017
drawing number	

A-5




SOUTH ELEVATION / SECTION

SCALE: 1/4"=1'-0"

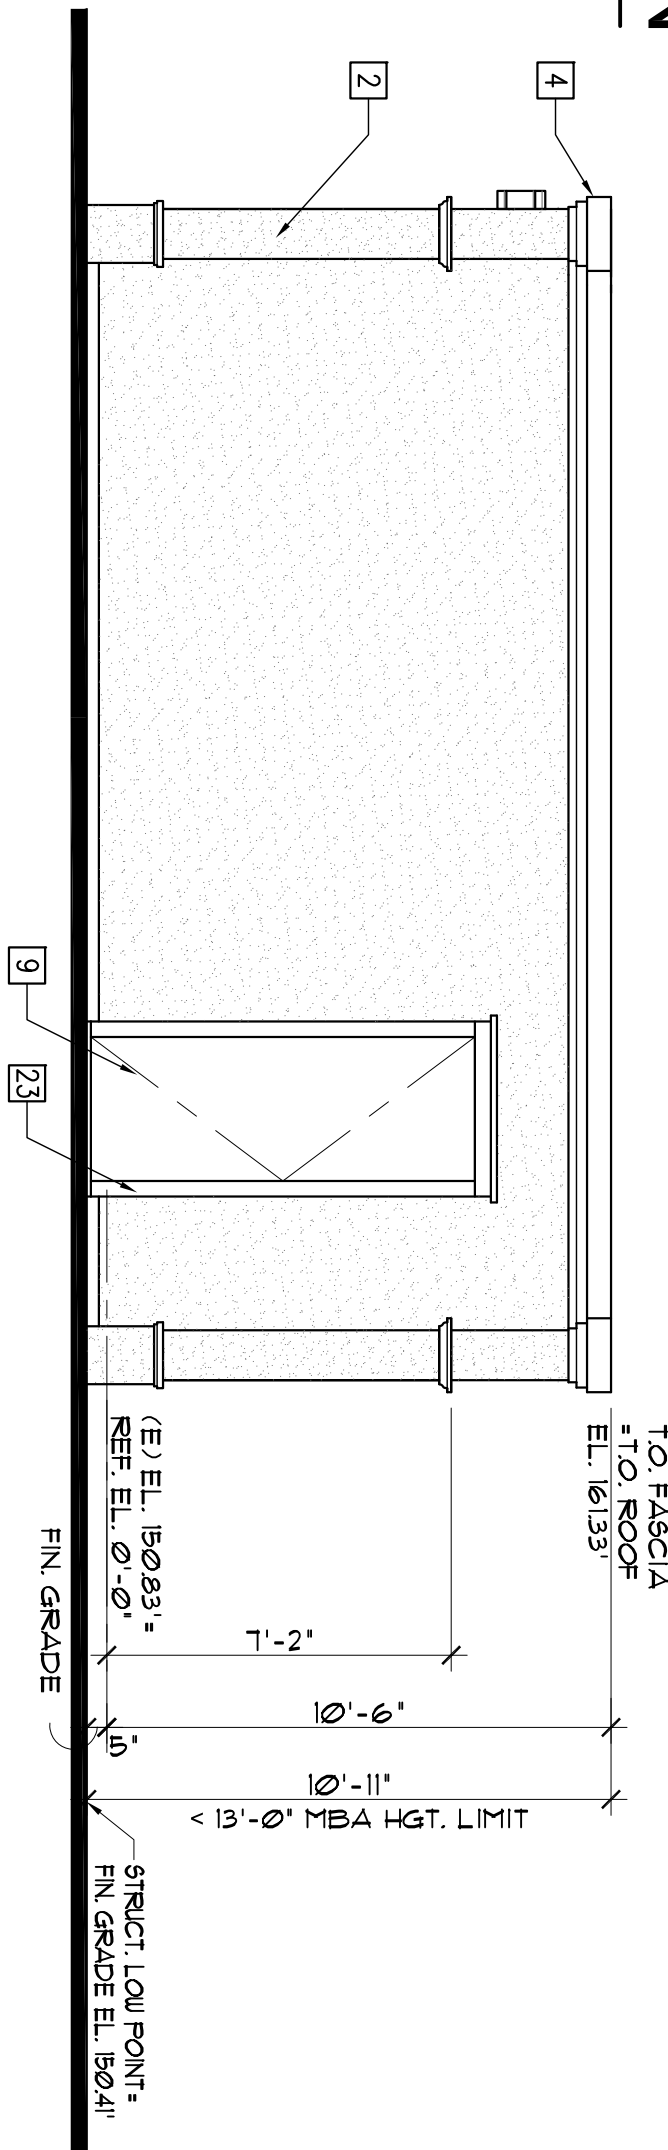

GARAGE - SOUTH ELEVATION

SCALE: 1/4"=1'-0"

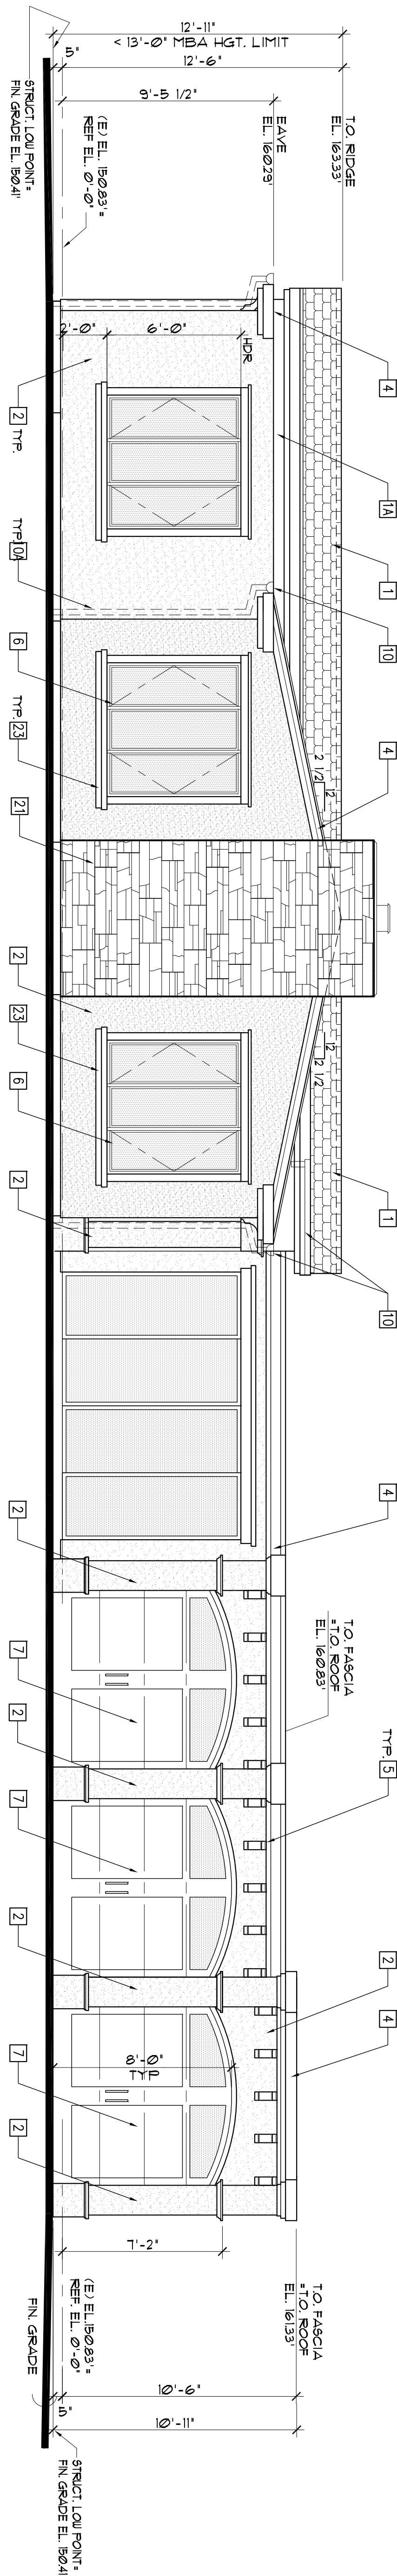

WEST ELEVATION

SCALE: 1/4"=1'-0"

- NOTES:

1. MAXIMUM BUILDING HEIGHT IS 28 FEET FOR ZONE RS4 PER CITY OF DANA POINT RESIDENTIAL DEVELOPMENT STANDARDS SECTION 9.09.020.
2. MAXIMUM ROOF HEIGHT FOR THIS LOT ALLOWED BY MONARCH BAY ASSOCIATION STANDARDS IS 13 FEET ABOVE FINISH GRADE.
3. THE PROPOSED MAXIMUM ROOF HEIGHT OF 12'-11" FOR THIS PROJECT IS IN COMPLIANCE WITH THE CITY OF DANA POINT RESIDENTIAL DEVELOPMENT AND MONARCH BAY ASSOCIATION STANDARDS.

KEY NOTES-□

15. HARBAGEFACE: PLANTER WALLS - NATURAL STONE VENEER
SPLIT FACE PLASTERING, COLOR: CREAM
16. 8 X 8 POLYMER HARDWOOD COLUMN WRAP BY AZEK
COLOR: MAHOGANY
17. BEAM WRAP W/ POLYMER HARDWOOD BY AZEK
COLOR: MAHOGANY
18. (N) DIRECT VENT FIREPLACE: MFR MARTIN FIREPLACE, MODEL
5B540266 STAINLESS STEEL
19. (N) STAINLESS STEEL BUILT-IN BARBECUE UNIT
20. (N) EXTERIOR LIGHT FIXTURE.
21. EXISTING CHIMNEY WITH NEW NATURAL STONE VENEER
22. (N) DIRECT VENT PIPE WITH GAS DIRECT TERMINATION CAP.
23. WINDOW SURROUND: SMOOTH PLASTER FINISH, COLOR: WHITE

94. EXTERIOR FOLDING DOORS: ALUMINUM CLAD WOOD, MFR. SIERRA PACIFIC, COLOR: BRONZE *024
10. GUTTERS: ALUMINUM ROUND, CUSTOM FABRICATED, MFR. RG6 COLOR: TO MATCH ROOFING TILE
104. DOWNSPOUTS: ALUMINUM ROUND, CUSTOM FABRICATED, MFR. RG6 COLOR: WHITE
- CONNECT TO EXISTING DRAINAGE SYSTEM.
11. DECKS: POLYMER HARDWOOD, VINTAGE COLLECTION MFR. AZEK COLOR: MAHOAGANY.
12. GARDEN WALLS: 8" THICK CONCRETE BLOCK COLOR: TO MATCH SMOOTH PLASTER WALLS.
13. GATES: POLYMER HARDWOOD MFR. AZEK COLOR: MAHOAGANY
4. DRIVEWAY: CONCRETE, COLOR: OUTBACK/PEBBLE MFR. DAVE'S

3. WALLS-ACCENT: NATURAL STONE VENEER, SPLIT FACE TRAVERTINE, COLOR: CREAM
4. FASCIA TRIM: PAINTED WOOD, MFR: DUNN-EDWARDS COLOR: WHITE DEU 380
5. WOOD TRIM: PAINTED WOOD, MFR: DUNN-EDWARDS COLOR: DEU 380
6. WINDOWS- ALUMINUM CLADED WOOD, CASEMENT TYPE UNO, MFR: SIERRA PACIFIC, COLOR: BRONZE W214
7. GARAGE DOORS: STEEL, POLYSTYRENE INSULATED MFR: AYLORER CLASSICA COLLECTION, COLOR: WHITE
8. ENTRY DOOR: WOOD, CUSTOM BUILT, MAHOGANY, CLEAR FINISH
9. EXTERIOR DOORS: ALUMINUM CLAD WOOD, MFR: SIERRA PACIFIC, COLOR: BRONZE W214

1. ROOF (GABLE): CLASS "A" LIGHTWEIGHT CONCRETE TILES TYPE "BEL-AIR" OVER 1X3 ELEVATED BATTEN SYSTEM BY EAGLE ROOFING PRODUCTS (1470-1165, ERIE#00) / OVER CLASS "A" TORCH APPLIED 3-PLY MODIFIED BITUMEN MEMBRANE RUBEROID® APP BY GAF (UL-ER 1306-02) CONCRETE TILE COLOR: "2181 DRUM GRAY" RANGE
- 1A. ROOF (FLAT): CLASS "A" TORCH APPLIED 3-PLY MODIFIED BITUMEN MEMBRANE RUBEROID® APP SYSTEM BY GAF (UL-ER 1306-02). EL GABLE FOR 20'-YEAR NDL MANUFACTURE WARRANTY.
- CAP SHEET COLOR: GRANULE TO MATCH CONCRETE ROOFING TILE.
2. WALLS-FIELD: SMOOTH PLASTER.
- FINISH: SANTA BARBARA COLOR: "50 CRYSTAL WHITE," MFR: LA HABRA

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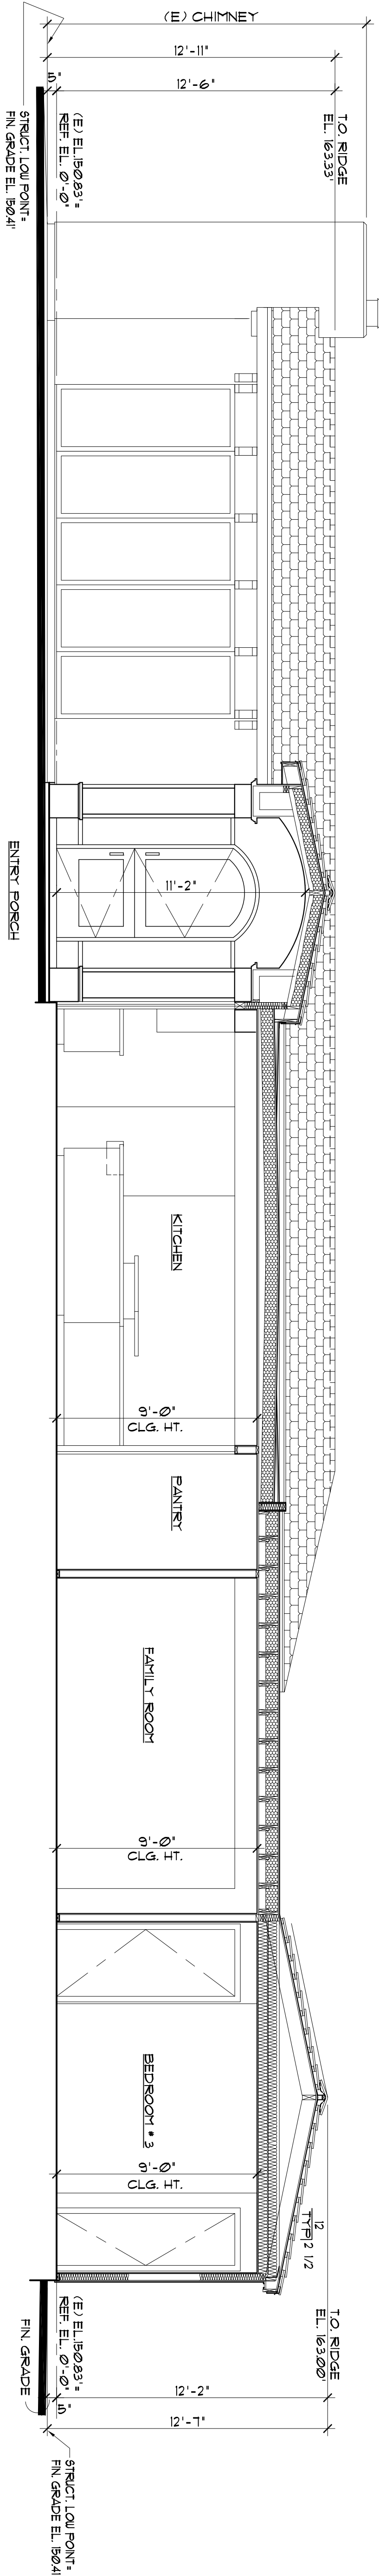
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Drawing title


BUILDING
SECTIONS

Scale	AS NOTED
Date	10/23/2017
Drawing number	A-6



SECTION - A

SCALE: 1/4" = 1'-0"

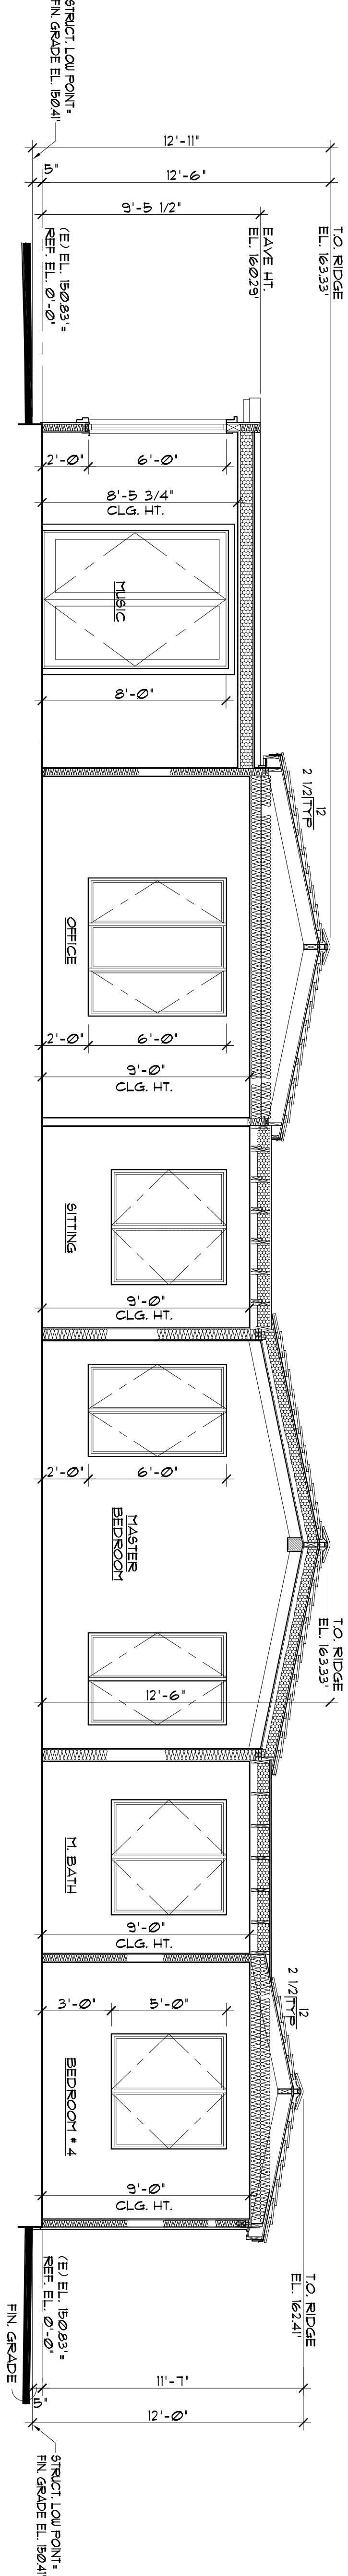

SECTION - B

SCALE: 1/4" = 1'-0"

KEY NOTES – □

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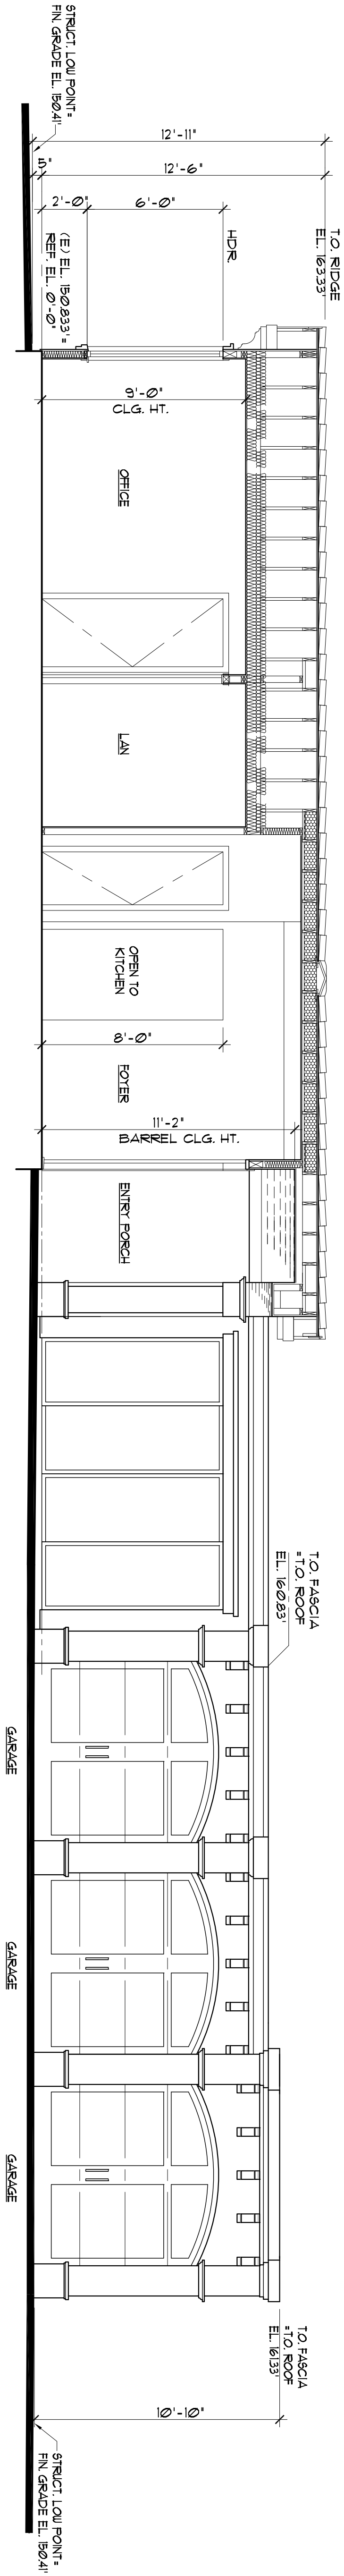
BUILDING
SECTIONS

scale AS NOTED

date 10/23/2017


drawing number

A-7



SECTION - C

SCALE: 1/4" = 1'-0"

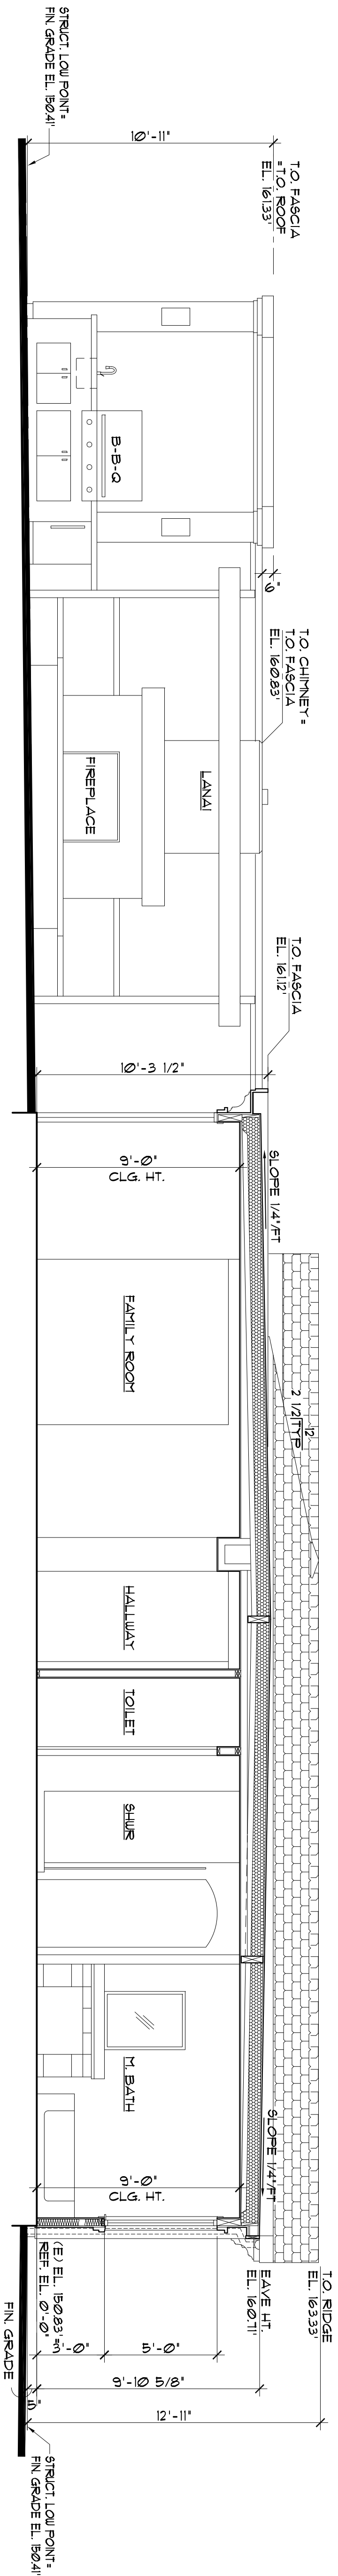

SECTION - D

SCALE: 1/4" = 1'-0"

KEY NOTES - □

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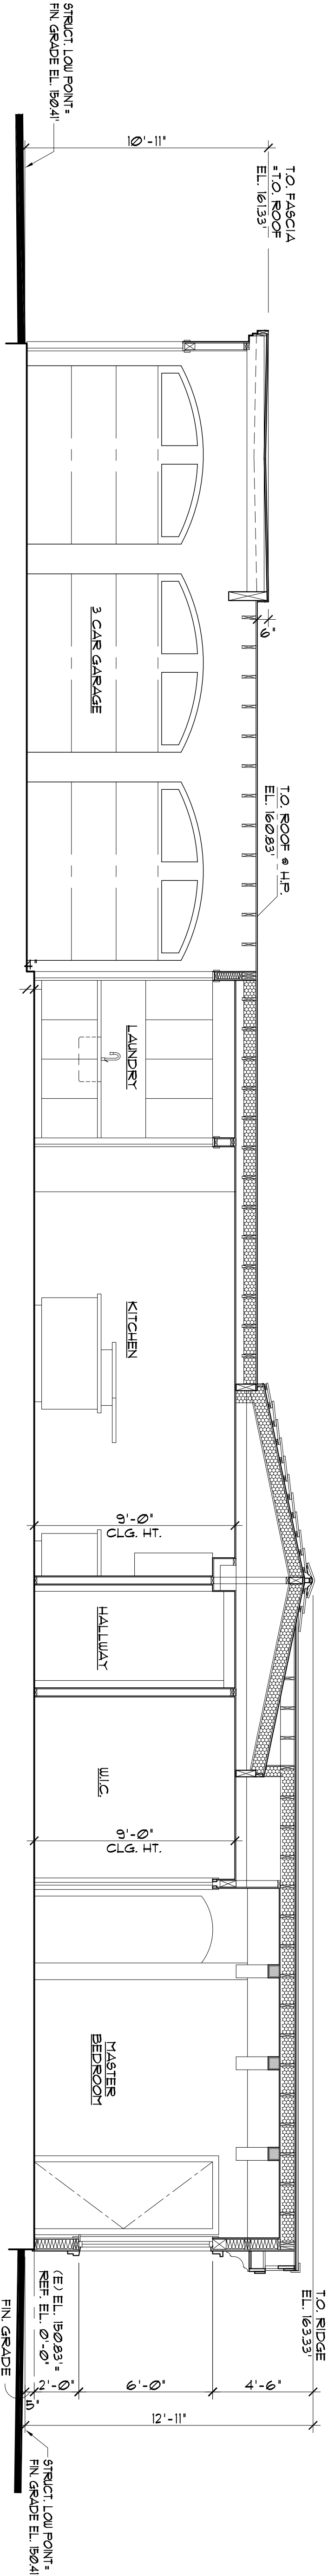
seals and signatures

drawing title

BUILDING
SECTIONS


scale AS NOTED
date 10/23/2017
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A-8




SECTION - E

SCALE: 1/4"=1'-0"

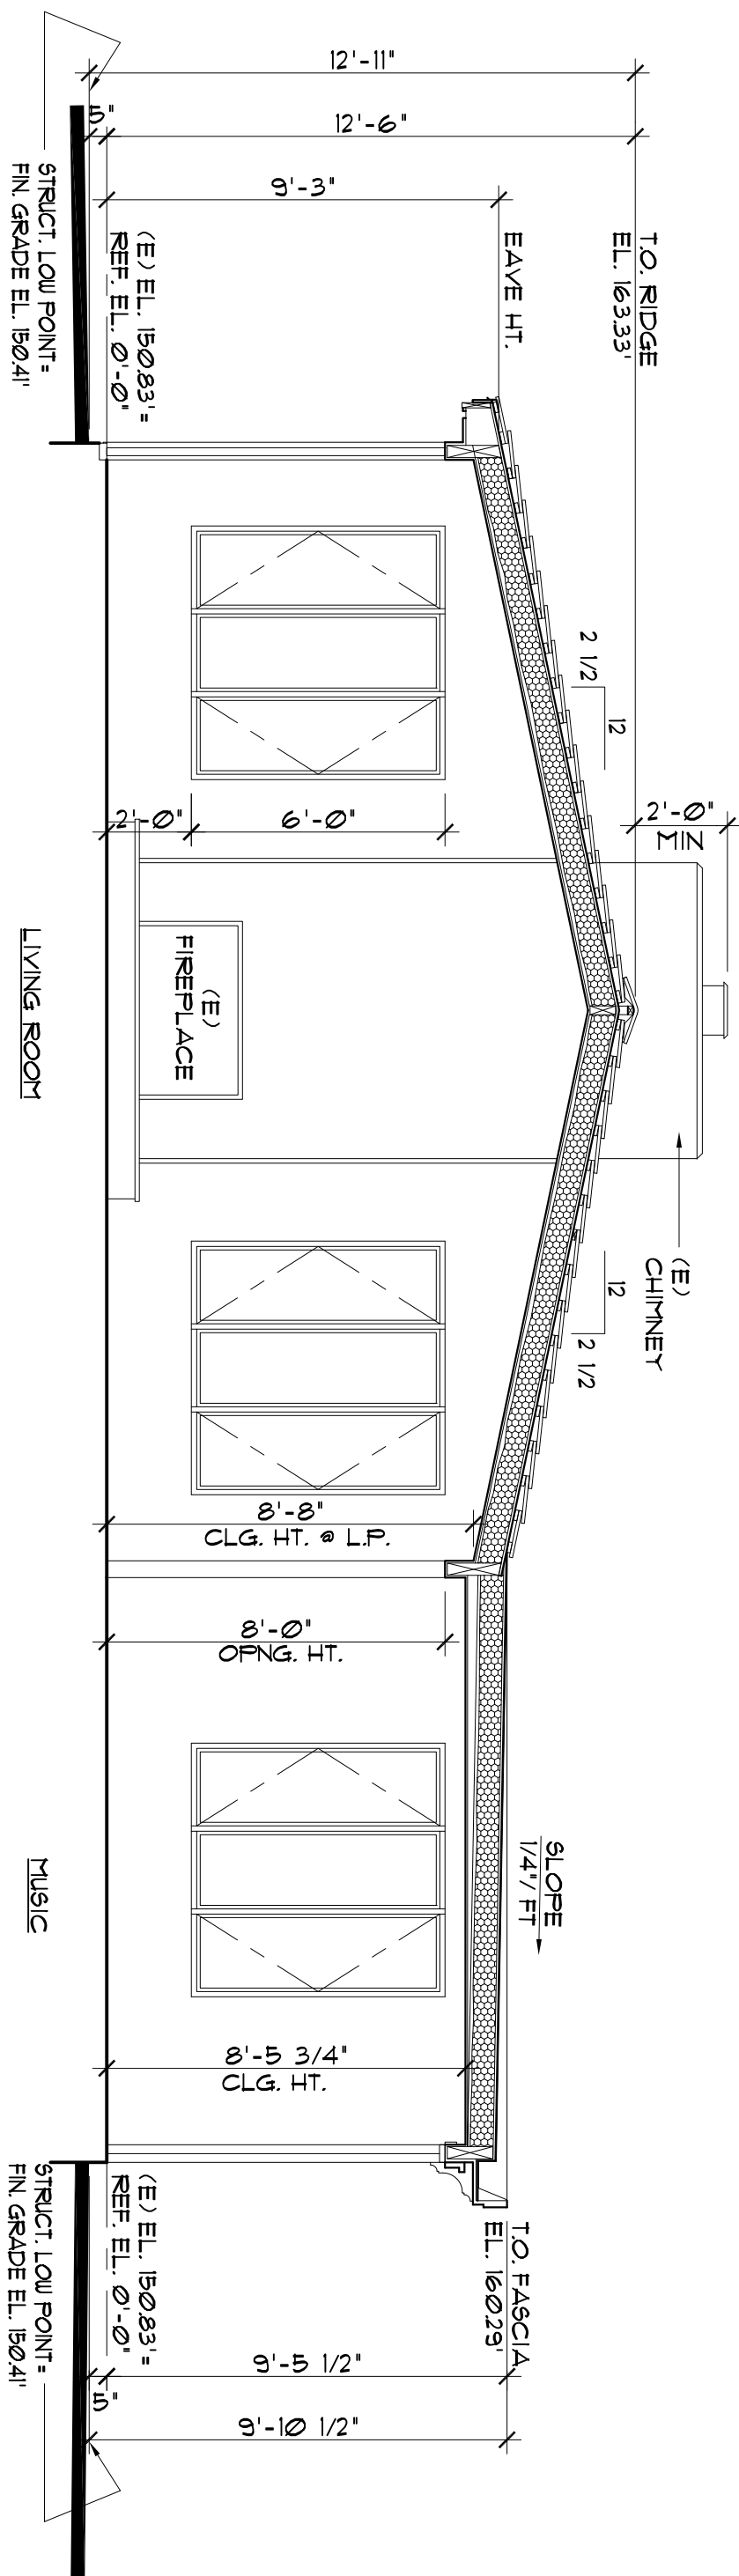

SECTION - G

SCALE: 1/4"=1'-0"

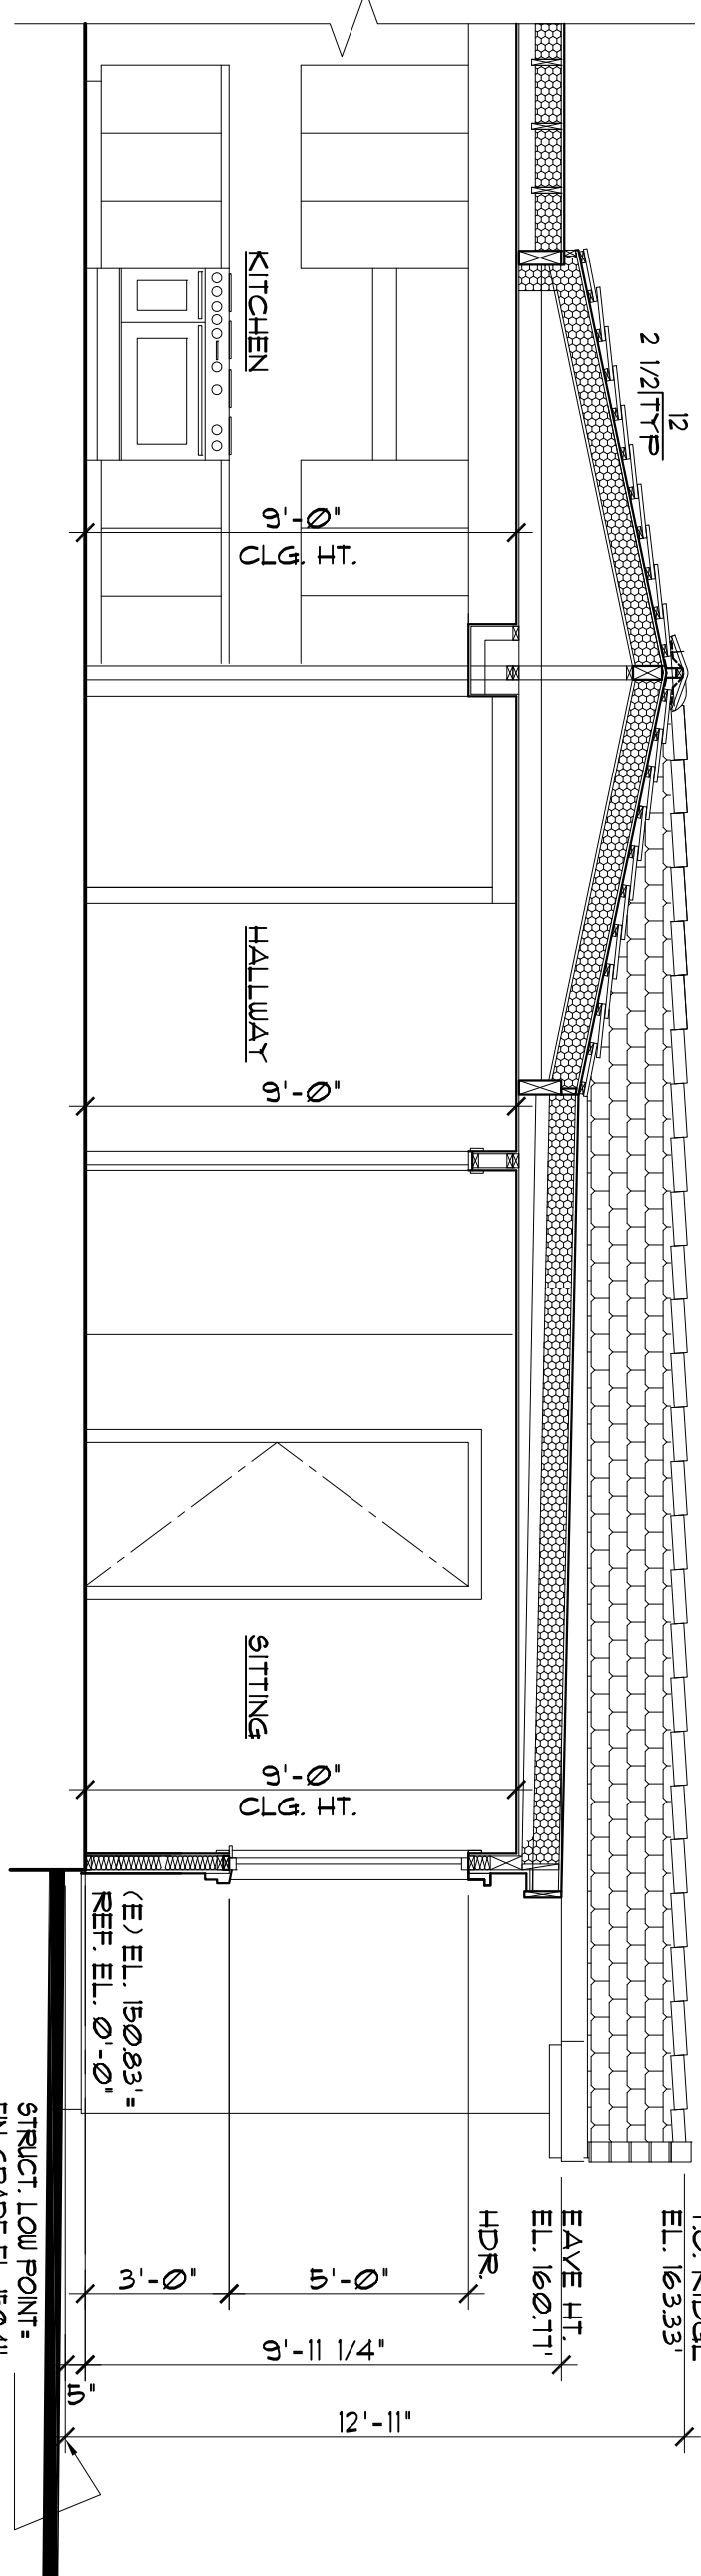

SECTION - F

SCALE: 1/4"=1'-0"

KEY NOTES - □

GENERAL NOTES:

1. TOTAL NEAR LENGTH OF ALL WALLS: 670'-0"
A. EXTERIOR: 427'-11"
B. INTERIOR: 242'-11"
2. LENGTH OF WALL TO BE REMOVED: 200'-8"
A. EXTERIOR: 114'-10"
B. INTERIOR: 183'-10"
PERCENTAGE OF TOTAL WALLS: 44.5%
3. WALLS TO BE RECONSTRUCTED: 11'-6"
A. EXTERIOR: 11'-6"
B. INTERIOR: 0'-0"
PERCENTAGE OF TOTAL WALLS: 1.7%
4. LENGTH OF WALL TO REMAIN: 304'-4"
A. EXTERIOR: 313'-11"
B. INTERIOR: 71'-3"
PERCENTAGE OF TOTAL WALLS: 57.4%

DEMO KEY NOTES: – □

1. KITCHEN COUNTERTOP, SINK, OVEN RANGE AND CABINETS TO BE REMOVED.

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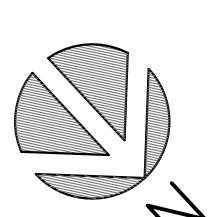
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DEMOLITION PLAN

scale	1/4" = 1'-0"
date	10/23/2017
drawing number	

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(RVPi CONSTRUCTION IN)

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949-309-6691

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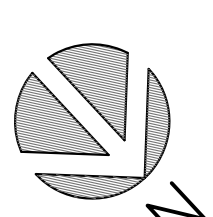
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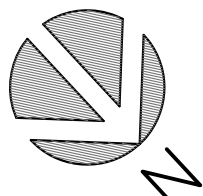
- PV MODULE ARRAY AREA - O
- ① APOLLO TILE II: 43 MODULES @ 60W/EA = 2,580 W
 - ② APOLLO TILE II: 60 MODULES @ 60W/EA = 3,600 W
 - ③ APOLLO TILE II: 28 MODULES @ 60W/EA = 1,680 W
 - ④ APOLLO TILE II: 18 MODULES @ 60W/EA = 1,080 W
 - ⑤ SOLSTICE MODULE: 5 UNITS @ 300W/EA = 1,500 W
- TOTAL: 10,440 W
OR: 10.44 KW

BASIS OF DESIGN PV MODULES BY: "CERTIFIED SAINT-GOBAIN

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ROOF PLAN
PV MODULES

scale 1/4"=1'-0"


date 10/23/2017

drawing number


PV-1

ROOF PLAN- PV MODULES


SCALE: 1/4"=1'-0"

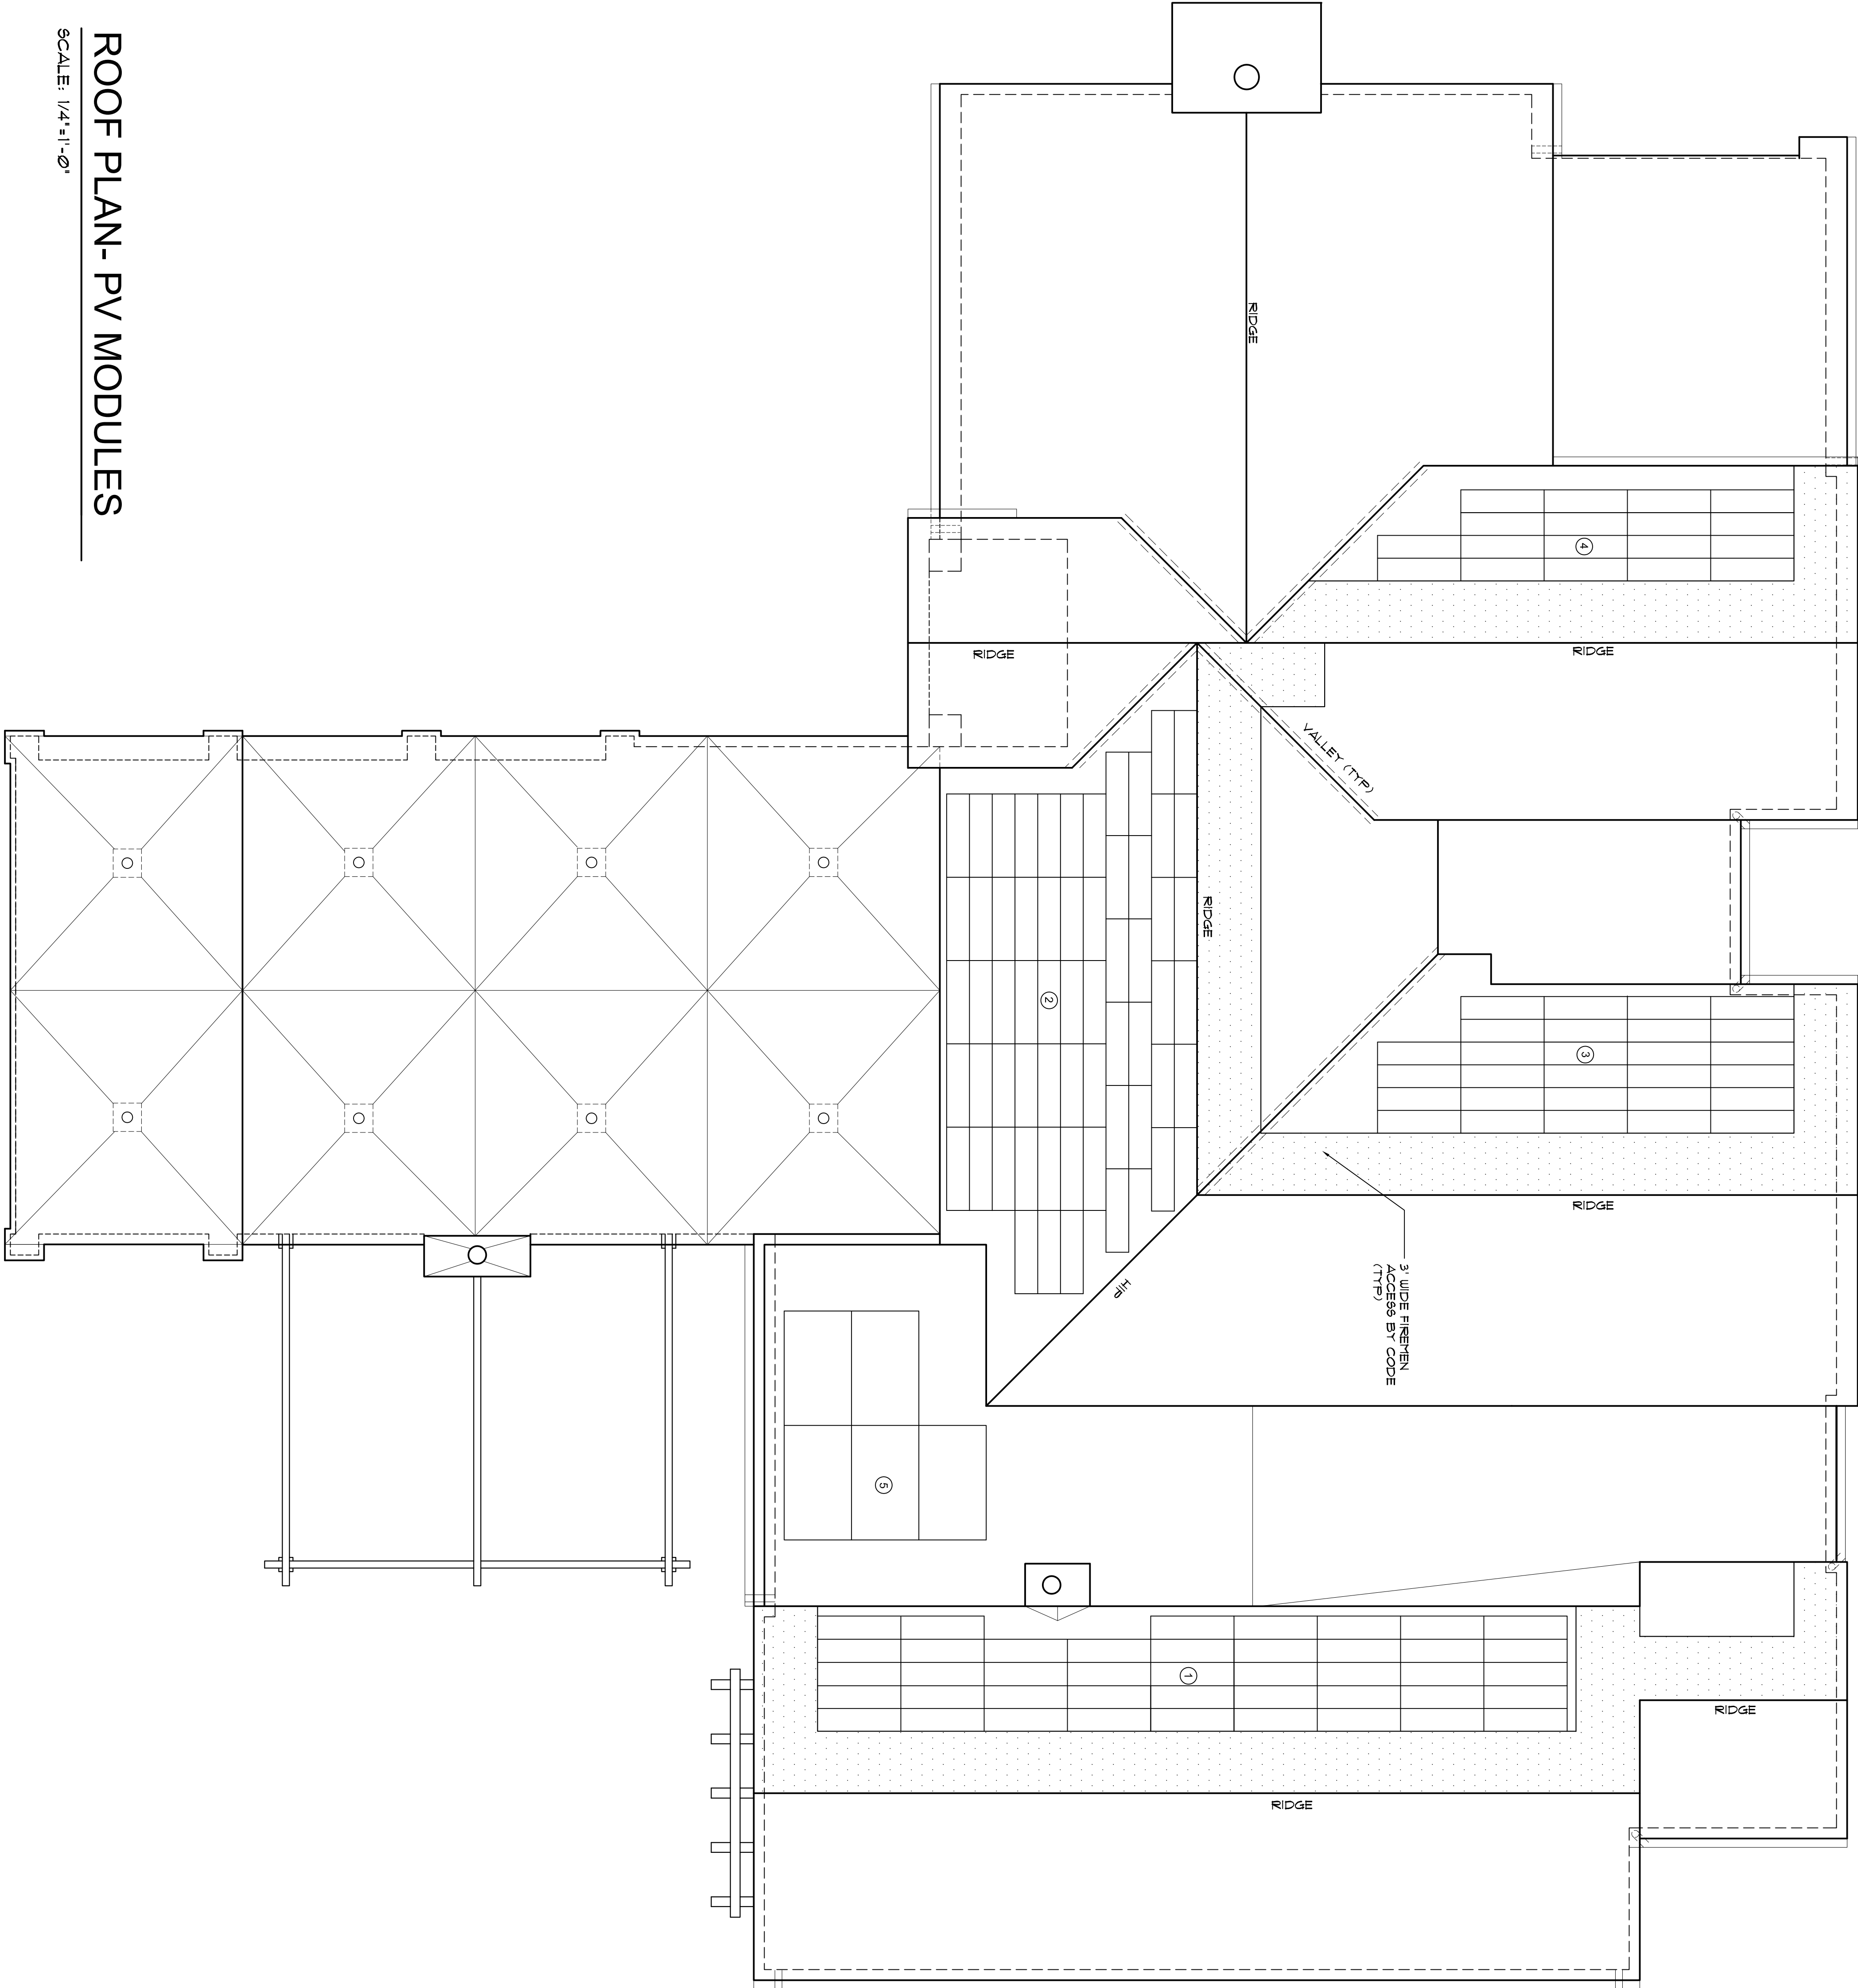

SOLAR PLAN SYMBOLS

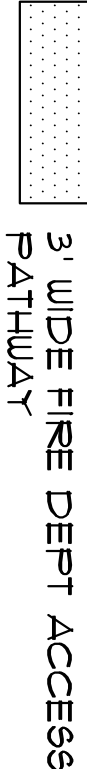


3' WIDE FIRE DEPT ACCESS
PATHWAY

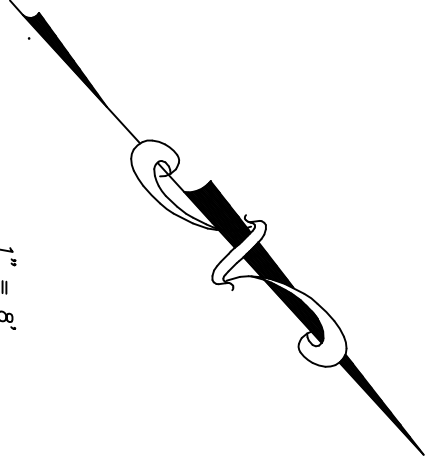

1" = 8'

LEGEND

- TC = TOP CURB
- FS = FINISH SURFACE
- TS = TOP STEP
- TG = EXISTING GROUND
- TP = TOP PLANTER
- TP = TOP PLANTER
- FF = FINISH FLOOR
- GF = GARAGE FINISH FLOOR
- BW = BLACK WALK
- SCO = SEWER CLEANOUT
- MP = POWER POLE
- WM = WATER METER
- STM = TEMPORARY BENCHMARK
- STFK = STAKEHOLD FOUND NOTHING
- EL = ELEVATION
- FL = PROPERTY LINE

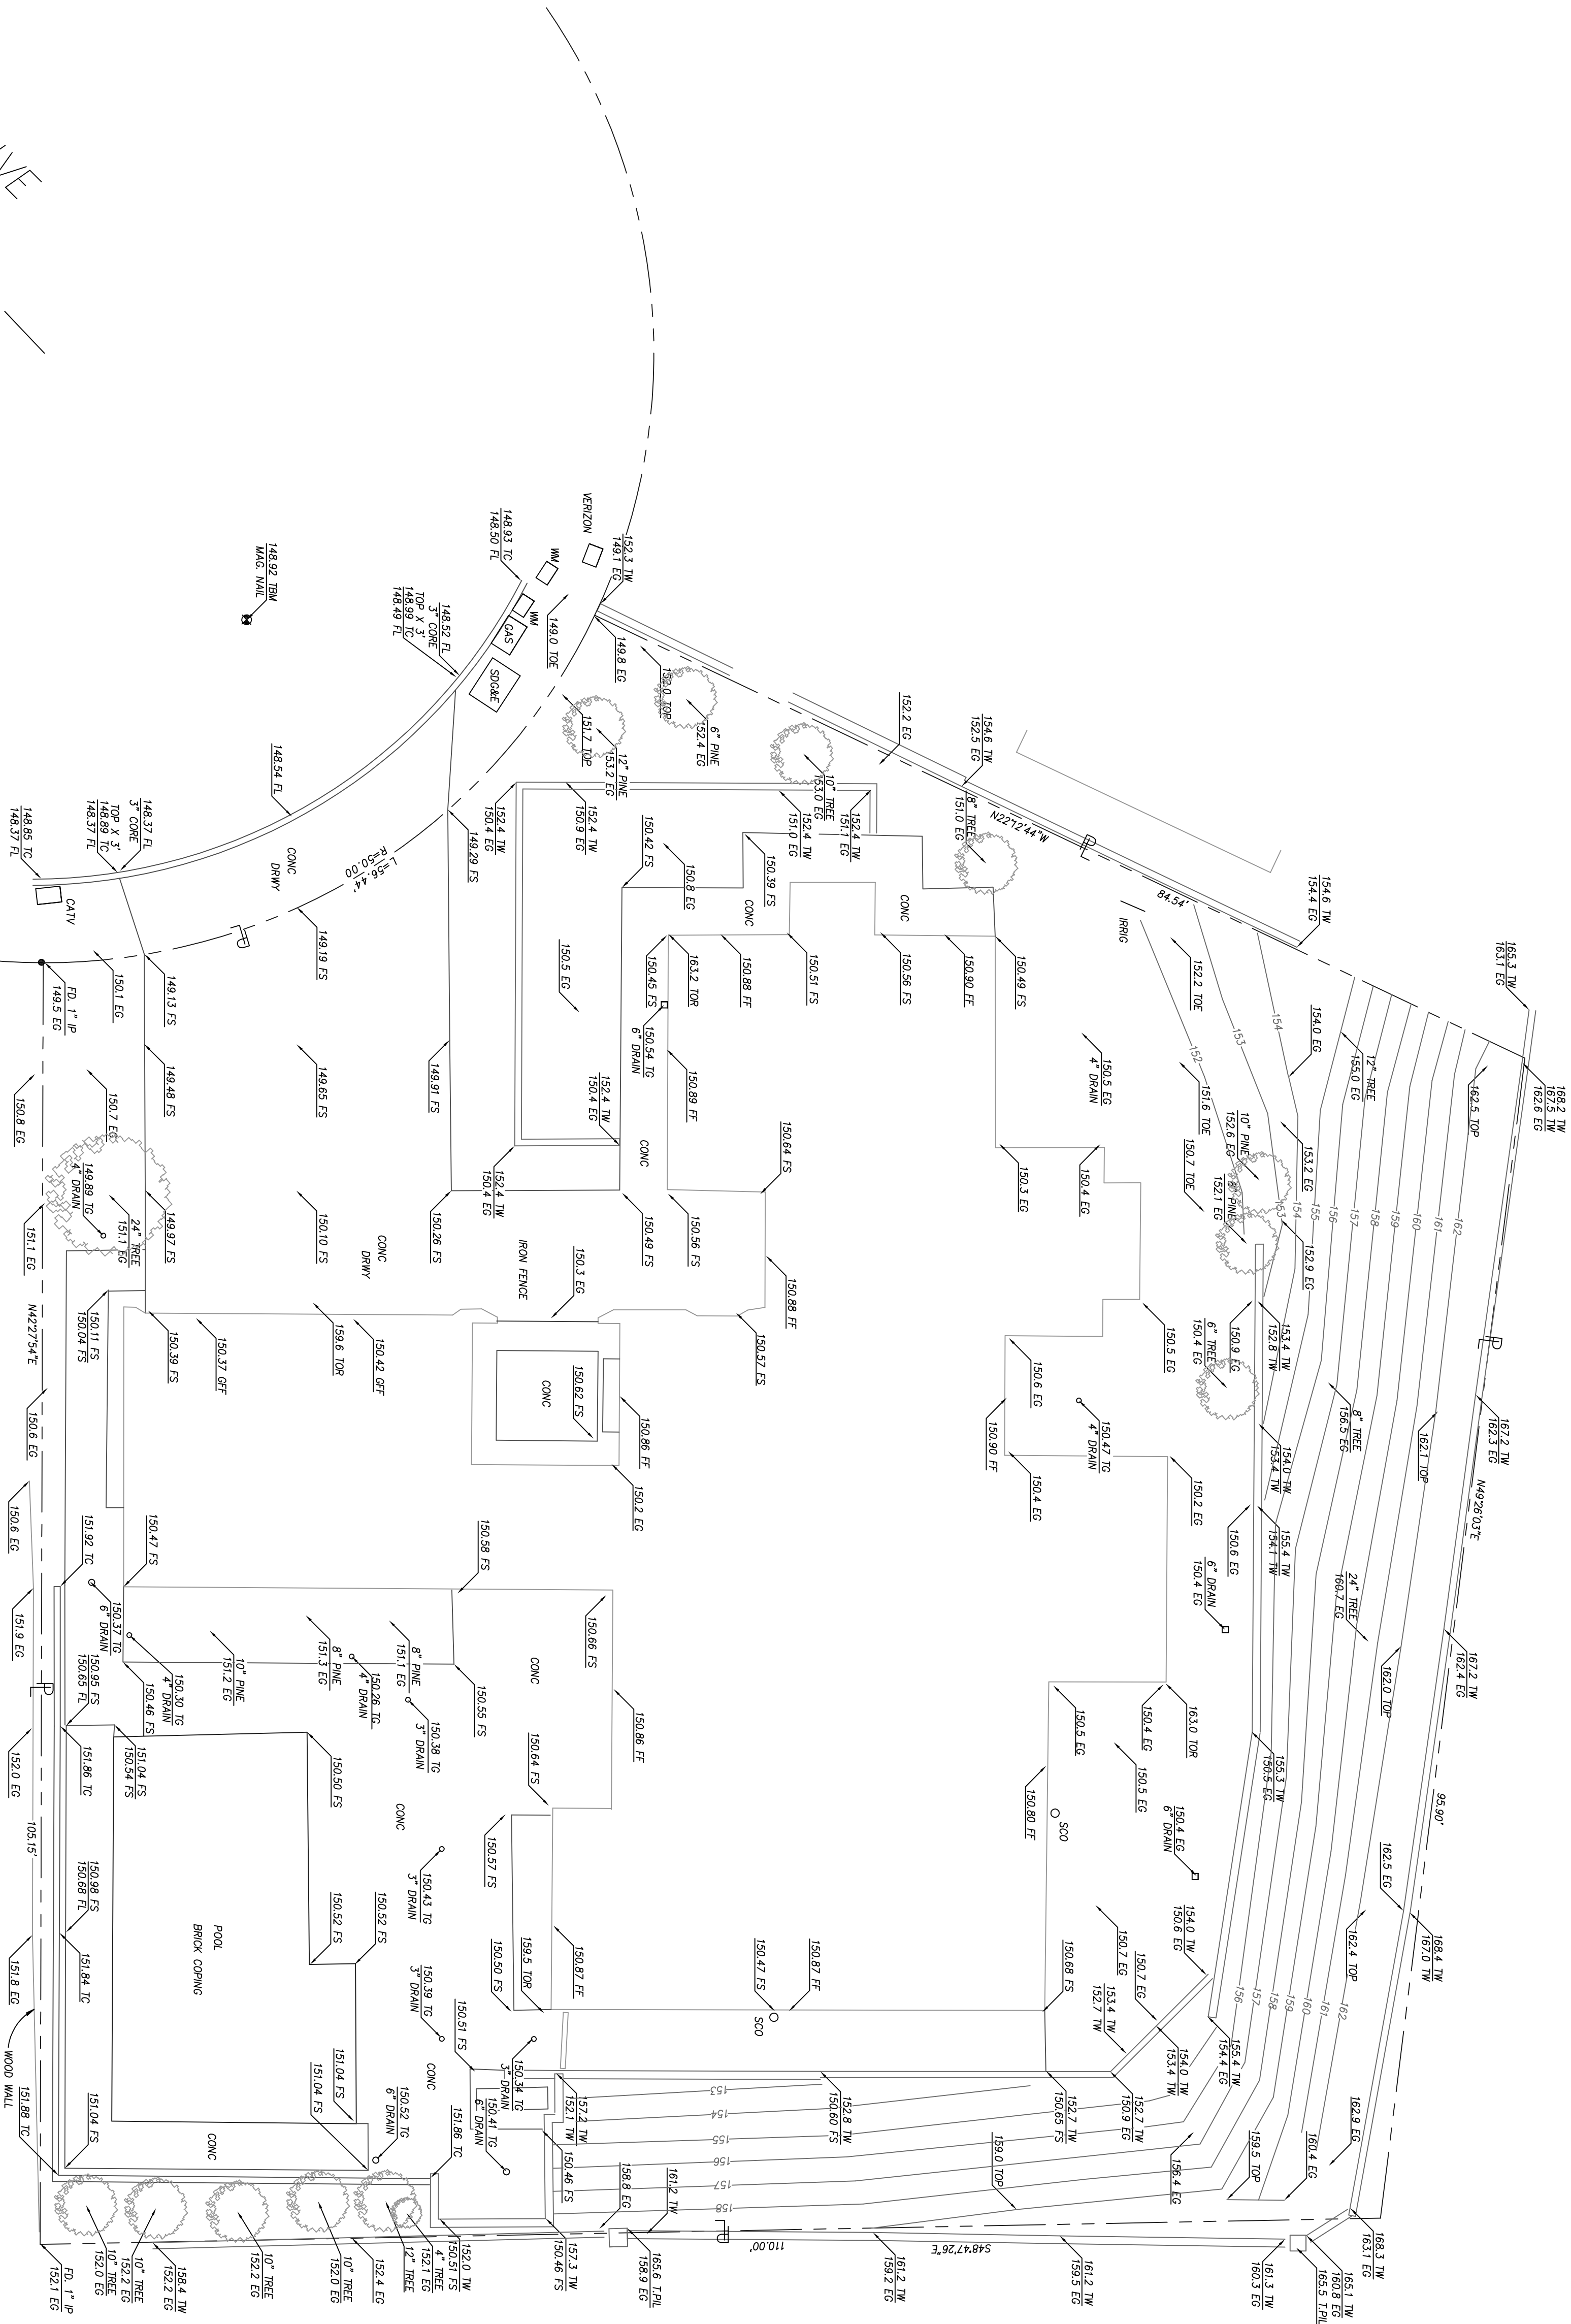

MONARCH BAY DRIVE



TOPOGRAPHIC MAP

8 SCALE LOT 36 TRACT NO. 3839
AUGUST 2017
48 MONARCH BAY DRIVE DANA POINT CA.

BOUNDARY NOTE:
BOUNDARY SURVEY. THE TOPOGRAPHIC FEATURES AS SHOWN
ON THIS MAP MAY BE ADJUSTED RELATIVE TO THE PLAT UPON COMPLETION
OF A BOUNDARY SURVEY.

COS BENCHMARK 3"-35.04 ELEV= 157.955 NAD83 DATUM
SOUTH COAST SURVEYING 3214 CLAY ST. NEWPORT BEACH CA. (949)531-8840

ERROR: syntaxerror
OFFENDING COMMAND: --nostringval--

STACK:

/Title
()
/Subject
(D:20170906165645-07'00')
/ModDate
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/Keywords
(PDFCreator Version 0.9.5)
/Creator
(D:20170906165645-07'00')
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(Mark)
/Author
-mark-